

PLANNING COMMISSION REGULAR AGENDA

DATE: June 25, 2024 7:00 PM

PLACE: Council Chamber

INFORMATION FOR THE PUBLIC

Information regarding meetings, including agenda materials, schedules and more, please visit the City's Meetings & Agendas webpage: https://www.cityofmartinez.org/government/meetings-and-agendas.

REMOTE PARTICIPATION

This meeting will be conducted in-person in the City Hall Council Chamber and shall be aired in real time via Zoom. The City cannot guarantee the public's access to teleconferencing technology, nor guarantee uninterrupted access as technical difficulties may occur from time to time. If attending via Zoom, please join us by choosing any of the following options:

Via Mobile Phone or Desktop, using the Zoom App direct link: https://cityofmartinez-org.zoom.us/j/95400423258

1. Via Web Browser, from https://zoom.us/join

a. Webinar ID: 954 0042 3258

b. Passcode: 871769

2. Via Phone by calling (669) 900-6833 and enter the provided meeting details above.

PUBLIC COMMENTS

Public comments can be made in person at the meeting or submitted in writing. Written comments must be received by 12pm, the day of the meeting. For information on how to submit written comments, please visit the City's Meetings & Agendas webpage linked above.

ADA ACCOMODATIONS

In accordance with the Americans with Disabilities Act and California law, the Council Chamber is wheelchair accessible and disabled parking is available at City Hall. If you are a person with a disability and require modifications or accommodation to attend and/or participate in this meeting, please contact the City Clerk's Office at (925) 372-3512. Notification 48 hours prior to the meeting will enable the City to make reasonable arrangements to ensure accessibility.

AGENDA CONTINUED TO PAGE 2

PLANNING COMMISSION REGULAR AGENDA

CALL TO ORDER - PLEDGE OF ALLEGIANCE

ROLL CALL - Commissioners Jonathan Bash, Joseph Evans, Susan Gustofson, Rochelle Johnson, Jason Martin, John Klopp (Alternate); Vice Chair Tracey Casella and Chair Sean Trambley

CIVILITY STATEMENT - As your appointed Governing Board, we will treat each other and the public with patience, civility, and courtesy as a model of the same behavior we wish to reflect in Martinez for the conduct of all City business and community participation. This includes respect for everyone's First Amendment Right to voice their opinion on matters within the City's subject matter jurisdiction, even if that opinion is different from our own. The decisions made tonight will be for the benefit of the Martinez community and not for personal gain.

PUBLIC COMMENT - For items not on the agenda. Non-agenda public comment is limited to matters which are within the subject matter jurisdiction of the Commission, and which are not action items listed elsewhere on the agenda.

CONSENT

1. Approve the Planning Commission Meeting Action Minutes, dates May 14, 2024. Action Minutes, dated May 14, 2024

REGULAR

- 2. Determine who shall serve as Chair and Vice Chair of the Planning Commission from July 1, 2024 through June 30, 2025.
 - Staff Report Chair and Vice Chair Selection
- Conduct a public hearing and adopt Planning Commission Resolution No. 24-04, approving the
 Design Review application for a new 3,779 square foot single-family dwelling, located at 140
 Glendora Drive, Assessor's Parcel Number 370-140-003-2, subject to conditions of approval.
 Staff Report 140 Glendora Drive Design Review
 Attachment A Planning Commission Resolution No. 24-04
- 4. Conduct a public hearing and adopt Planning Commission Resolution No. 24-05, forwarding a recommendation to the City Council to approve amendments to the Growth Management Element of the General Plan.

Staff Report - Growth Management Element Update Attachment A - Planning Commission Resolution No. 24-05 Exhibit A - Draft Growth Management Element Update

COMMISSION ITEMS

PLANNING MANAGER UPDATES

PLANNING COMMISSION REGULAR AGENDA

COMMUNICATIONS

ADJOURNMENT - Adjourn to a Planning Commission Regular Meeting on Tuesday, July 9, 2024, at 7:00 p.m.

By June 21, 2024, a true and correct copy of this agenda was posted on the City Hall Kiosk, located at 525 Henrietta Street, Martinez, CA 94553, and on the City website at www.cityofmartinez.org.

Dee Dee Fendley, Administrative Aide III

https://martinez.granicus.com/MediaPlayer.php?view_id=7&clip_id=1590&meta_id=124002*

Full details are available via audio/video recording on our <u>website</u>. *Microsoft Internet Explorer browser is recommended for video-viewing compatibility or enable Adobe Flash on your default browser*.

Commissioners on Video Confe	erence	City Staff on Video Conference		
Chair Sean Trambley	Present	Michael P. Cass, Planning Manager		
Vice Chair Tracey Casella	Present	Brandon Northart, Associate Planner		
Commissioner Jonathan Bash	Present	Dee Dee Fendley, Administrative Aide III		
Commissioner Joseph Evans	Present	Teresa Highsmith, City Attorney		
Commissioner Susan Gustofson	Present			
Commissioner Rochelle Johnson	Present			
Commissioner Jason Martin	Present			
Commissioner John Klopp	Present			
(Alternate)				

Call to Order	
Meeting called to order at 7:00 p.m.	

	Public Comment (01:52 in video)
None	

Consent Calendar (02:10 in video)					
1. Approval of the April 9, 2024 Planning Commission Action Minutes					
Speakers:	None				
Public	None				
Comment:					
Closing	None				
Comments:					
Motion to:	Approve				
Motion by:	Commissioner Martin Seconded By: Vice-Chair Casella			sella	
Motion	Sean Trambley	Aye	Susan Gustofson	Aye	
passed 7-0	Tracey Casella	Aye	Rochelle Johnson	Late	
	Jonathan Bash	Aye	Jason Martin	Aye	
7-0	Joseph Evans	Aye	John Klopp (Alternate)	Aye	

Regular Items (02:53 in video)

2. Conduct a public hearing and adopt Resolution No. 24-03, recommending the City Council approve a Zoning Text Amendment to amend the Martinez Municipal Code ("MMC") by 1) amending Chapter 22.04 (Definitions) to add definitions for "Concessions" and "Waivers" and 2) establishing new and amending existing regulations for California State Density Bonus Law

("SDBL") by revoking Chapter 22.57 (Density Bonus) and adding Chapter 22.80 (Density Bonus).				
Speakers:	 Brandon Nort outlining the properties of the properties of the properties of the presentation outlining the properties of the presentation outlined to use the presentation outlined to the presentation outli	roject. ager Micha its outlined that was p e exact lang cation purp asella clar due to the	el P. Cass clarified the the in the presentation do not characteristics. The clause and reference the Goroses only. If it is planted in the changes made in public comment were	ree non- ange the edits are vernment to the
Public Comment:	None			
Closing Comments:	qualifications needs housing properties con • Vice-Chair Caqualifications. based on the recommissioner to layman's term and how that verses to layman to layman's term and how that verses to layer the layer term and layer than the layer term and layer term	for the low good tinue to quate asella asked she question and the control of the	sked how converting legal future updates to the Munici t applicants.	d special in these ines the ents were anguage pal Code
Motion to:	approve a Zoning Municipal Code ((Definitions) to add and 2) establishing California State D Chapter 22.57 (De	Text Ame ("MMC") k definitions I new and lensity Bou cluding the	recommending the City endment to amend the by 1) amending Chapte for "Concessions" and "Vamending existing regular nus Law ("SDBL") by the bus) and adding Chapte e three amendments staff	Martinez er 22.04 Vaivers" tions for evoking er 22.80
Motion by:	Vice-Chair Casella		Seconded By: Commissioner	Martin
Motion	Sean Trambley Tracey Casella	Aye Aye	Susan Gustofson Rochelle Johnson	Aye Aye
passed	Jonathan Bash	Aye	Jason Martin	Aye
7-0	Joseph Evans	Aye	John Klopp (Alternate)	N/A

Commission Items (23:39 in video)		
Comments/	None	
Updates		

Planning Manager Items (23:44 in video)

Comments/ Updates

Planning Manager Cass provided the following updates:

- The Zoning Ordinance Amendment presented at the previous Planning Commission meeting, including usues and conditional uses, industrial zoning incentives, temporary use permit regulations, and food truck regulations, was introduced by the City Council and is scheduled for a second reading tomorrow evening. If adopted, the new regulations will go into effect in 30 days.
- City staff is working with the Department of Housing and Community Development ("HCD") on our Housing Element and believe we are nearing certification. An update will be provided after certification is official.
- The City has two larger policy initiatives in the works, including 1) development incentives and community benefit program, and 2) lot consolidation and project phasing incentives. The City Council will provide feedback on both items at upcoming study sessions in June. This will be followed by bringing draft regulations to the Planning Commission for consideration and feedback.
- As a reminder, the City will suspend all Council and Commission meetings during the month of August.

Communications (27:27 in video)				
Comments/	None			
Updates				

Adjournment (27:37 in video)
Chair Trambley adjourned the meeting at 7:27 p.m.

Sean Trambley, Chair

Dee Dee Fendley, Administrative Aide III

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STAFF REPORT

Planning Commission

Date: June 25, 2024

To: Planning Commission

From: Michael P. Cass, Planning Manager

Prepared By: Michael P. Cass, Planning Manager

Subject: Selection of Chair and Vice Chair

Recommendation

Determine who shall serve as Chair and Vice Chair of the Planning Commission from July 1, 2024 through June 30, 2025.

Background

The Planning Commission's policy is to select, in June of each year, a member of the Planning Commission to serve as Chair and Vice Chair for a period of one year.

The Chair shall preside at all meetings to ensure meeting management of matters set forth on the relevant agenda. To this end, the Chair must exert sufficient control of the meeting to ensure that public and Commission discussion stay on agenda topic and fall within the subject matter jurisdiction of the Commission, while also providing an opportunity for all viewpoints to be heard and considered in a fair and impartial manner. The Vice-Chair shall preside in the absence of the Chair.

Environmental Review

The selection of the Chair and Vice Chair is exempt from the requirements of the California Environmental Quality Act ("CEQA") as it does not constitute a project pursuant to Public Resources Code Section 21065, and CEQA Guidelines Section 15060(c), 15061(b)(3), and/or 15378.

Fiscal Impact

None

Attachments

None



STAFF REPORT

Planning Commission

Date: June 25, 2024

To: Planning Commission

From: Michael P. Cass, Planning Manager

Prepared By: Brandon Northart, AICP, Associate Planner

Subject: 140 Glendora Drive – Design Review for a New Single-Family Dwelling

Planning Application No. 2023PLN-0038

Recommendation

Conduct a public hearing and adopt Planning Commission Resolution No. 24-04, approving the Design Review application for a new 3,779 square foot single-family dwelling, located at 140 Glendora Drive, Assessor's Parcel Number 370-140-003-2 (the "subject site"), subject to conditions of approval.

Background

Site Description

The subject site is an approximately 10.03-acre (436,907 square feet) undeveloped lot in the mixed Environmental Conservation District R-40 Single Family Residential ("ECD-R-40") zoning district. The project is also located within the Protected Open Space and Parks Overlay ("POPO Overlay") and is subject to the City's hillside development regulations. The subject site also includes a portion of a City-owned scenic easement at the southeastern part of the parcel, but the proposed project does not propose to encroach or modify the easement.

The project site is surrounded by the following land uses:

- North: Undeveloped and multi-family (ECD-R-40 zoning)
- West: Open space (ECD-R-40 zoning)
- South: Open space (ECD-R-40 zoning)
- East: Single-family homes (R-6.0 zoning)

See Figure 1 for an aerial photo of the subject site and surrounding properties.

Project Site

Figure 1 – Project Location

Project Description

The proposed project includes the construction of one new 3,779 square foot single-family dwelling. The project would have a total site coverage of 4,314 square feet, including the proposed dwelling and outdoor stairs, and only accounts for approximately one percent coverage of the 436,907 square feet lot. The proposed site plan is provided in Figure 2 below.

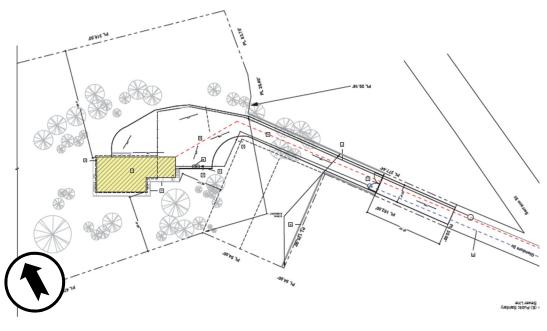


Figure 2 – Proposed Site Plan

The proposed dwelling would consist of four bedrooms, three bathrooms, an outdoor patio, and an attached three-car garage. The proposed dwelling is designed in the Mediterranean architectural style and the proposed exterior materials would be primarily painted with a white smooth stucco with white painted trim. The roof material would be an orange, Spanish-style tile. Elevations of the proposed home are provided in Figures 3 through 5 below.

rigure 3 — Proposed North Lievation

Figure 3 – Proposed North Elevation




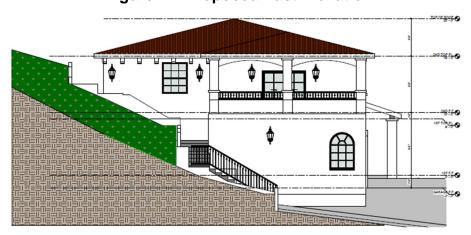


Figure 5 – Proposed West Elevation

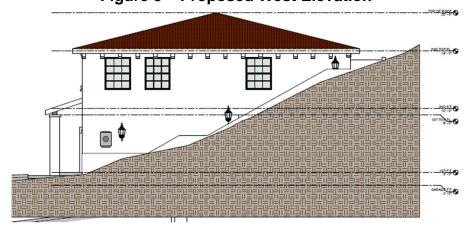

Discussion

The proposed project is consistent with all General Plan and Zoning requirements, as described below.

General Plan Consistency

On November 22, 2022, the City Council adopted General Plan 2035, which was subsequently amended on December 20, 2023. The subject site has a General Plan land use designation of Environmentally Sensitive Land ("ESL"), which applies to areas that are environmentally sensitive due to a variety of factors including steep terrain, soils instability, earthquake susceptibility, wildlife habitat and wildfire risk. These areas are suitable for open space, agriculture, parks and recreation, trails, and very-low-density residential development.

Approval of this project would be consistent with the General Plan's goals, such as Goal LU-G-1, which aims to "promote a balanced land use pattern, a mix of which enhances community character and serves the needs of existing and future residents." The proposed use is consistent with this goal as the parcel is undeveloped and would provide additional housing consistent with the intended size and density. The proposed project is also subject to Policy LU-P-1.2 and Implementation Measures LU-I-1.2a through LU-I-1.2l of General Plan 2035, which are related to the POPO Overlay and discussed in detail below.

POPO Overlay

In 2017, Martinez voters approved Measure I, establishing the POPO Overlay, which regulates allowable land uses and densities on certain open space designations that were applicable as of June 6, 2018. The General Plan 1973, as amended, was the applicable general plan during this time and the subject site maintained the land use designation of ESL.

The subject site was also located within the Franklin Hills sub-area of the General Plan 1973. In 1987, the Franklin Hills sub-area was further studied in the Franklin Hills Specific Plan and was adopted by the City Council as an amendment to the Martinez General Plan 1973.

Under the Martinez General Plan 1973, and as amended with the Franklin Hills Specific Plan, single-family dwellings at a density of one dwelling unit per acre and a site area of 20,000 square feet per unit are permitted in the ESL designation. The proposed project would consist of one residential unit on a 10.03-acre (436,907 square foot) lot, and would

be consistent with the use and density requirements of the ESL land use designation, and therefore the POPO Overlay.

Zoning Consistency

The subject site is in the mixed ECD-R-40 zoning district. The ECD zoning district only regulates permitted uses and residential density and defers all other development standards to the companion zoning district. The R-40 zoning district also regulates permitted uses and density but provides prescribed development standards. Both zoning districts permit single-family dwellings but have unique residential density requirements. As demonstrated in Table 1 below, the proposed project is consistent with all applicable density and development standards for both the ECD and the R-40 zoning districts.

Table 1 – Zoning District Development Standards

Criteria	R-40 Requirement	ECD Requirement	Existing	Proposed	Consistent
Lot size	40,000 sq. ft.	N/A	436,907 sq. ft.	No change	Y
Density	1 dwelling per 40,000 sq. ft. of lot area	1 dwelling on sites up to 20 acres	0	1	Y
Front setback	25 ft.	N/A	N/A	134 ft. 1 in.	Y
Side setbacks	1 st Story: 15 ft. 2 nd Story: 25 ft.	N/A	N/A	East: 49 ft. 11 in. West: >100 ft.	Y
Rear setback	25 ft.	N/A	N/A	69 ft. 4 in.	Y
Lot coverage	20 percent	N/A	0 percent	1 percent	Y
Height	25 ft.	N/A	N/A	25 ft.	Y
Parking	2 covered	N/A	N/A	3 covered	Y

Hillside Development Regulations

Martinez Municipal Code ("MMC") Chapter 22.33 (Hillside Development Regulations) requires projects which are proposed in areas which exceed a slope of 10 percent be subject to additional requirements, including the preparation of a slope and hazard map (included in Exhibit C of Attachment A). Projects are also required to demonstrate consistency with additional development standards as provided in MMC Section 22.33.040, which generally are intended to preserve natural views for the public and surrounding neighbors, minimize disturbances to hillsides and landscaping, and ensure high-quality residential design. The proposed project would comply with these standards as described below:

- A. The proposed development contains minimal grading aside from some associated with the driveway and under the building footprint, and minimizes disruption to the natural topography. No excessive retaining walls or cuts to the hillside are proposed. Any graded areas will be landscaped to minimize erosion.
- B. Areas of slope instability are not proposed for development.
- C. The proposed development preserves the appearance of scenic ridgelines as much as is feasible with the development of the parcel. Natural features like trees and rock/land formations are being retained to the maximum extent possible.
- D. The proposed development is similar in style to other existing residences in the vicinity. No existing residents' views will be negatively impacted. Massing, roof lines, exterior materials and colors, and decking blend well with the topography and natural landscape.
- E. The minimum lot area complies with the ECD-R-40 zoning district development standards and can accommodate the proposed development.
- F. A portion of a scenic easement is located at the subject site, but no encroachment or modification to the easement is proposed.
- G. The proposed development includes a landscaping plan that maintains the natural landscape by retaining all the existing landscaping and vegetation at the site. No additional modifications to landscaping are proposed.

Design Review Findings

For the design review approval to be granted, the Planning Commission must affirmatively make all the required findings outlined in MMC Section 22.34.045.

Following the first submittal by Joel Diaz (the "Applicant"), staff shared concerns that the proposed design had an inconsistent architectural style. Staff have worked closely with the Applicant to revise the proposed dwelling's design to reflect a modern Mediterranean style. Pursuant to staff's recommendations, the Applicant provided symmetry of the main entrance, removed the front entry half wall, revised color and materials for the dwelling and roof, provided symmetry in window design, revised garage door design and materials, revised railing materials, and revised column designs. A comparison of the proposed dwelling's initial and current proposed design, respectively, is provided in Figure 6 below.

With modifications recommended by staff and implemented by the Applicant, staff believes all the required findings may be affirmatively made as shown in Exhibit A of Attachment A and subject to the conditions of approval outlined in Exhibit B.



Figure 6 – Initial and Current Proposed North Elevation

Noticing Requirements/Public Outreach

In compliance with MMC Section 22.40.040 and Government Code Section 65091, a public hearing notice was published in the *Contra Costa News Register*, was posted at City Hall and at the subject site; and was mailed via first class or electronic mail to the Applicant, property owner(s), owners of property located within 300 feet of the subject site, local service agencies whose services might be affected by the project, and individuals who had previously filed written request for such notice a minimum of 10 days in advance of the original public hearing date. No public comments were received at the time this staff report was prepared.

Environmental Review

The proposed project is categorically exempt from the requirements of the California Environmental Quality Act ("CEQA") under CEQA Guidelines Section 15183, Projects Consistent with a Community Plan or Zoning. The project site is located within the Franklin Hills Specific Plan of the General Plan 1973, for which an Environmental Impact Report ("EIR") was prepared in 1987. The EIR anticipated development at the subject site for which the project would be consistent with and there are no project-specific significant effects which are peculiar to the project or its site. As such, no additional environmental review is required for the project. Mitigation measures from the Franklin Hills Specific Plan EIR remain applicable to the project and are included as conditions of approval in Exhibit B of Attachment A.

Fiscal Impact

Approval of the project would not result in any significant financial impacts, other than those normally collected for impact fees.

Attachments

- Attachment A Planning Commission Resolution No. 24-04
 - o Exhibit A Design Review Findings
 - o Exhibit B Conditions of Approval
 - o Exhibit C Project Plans

RESOLUTION NO. 24-04

A RESOLUTION OF THE PLANNING COMMISSION OF THE CITY OF MARTINEZ APPROVING THE DESIGN REVIEW APPLICATION FOR A NEW 3,779 SQUARE FOOT SINGLE-FAMILY DWELLING, LOCATED AT 140 GLENDORA DRIVE, APN 370-140-003-2, SUBJECT TO CONDITIONS OF APPROVAL PLANNING APPLICATION NO. 2023PLN-0038

WHEREAS, on July 12, 2023, Joel Diaz ("the Applicant") submitted Planning Application No. 2023PLN-0038, requesting design review approval for a new single-family dwelling, located at 140 Glendora Drive, Assessor's Parcel Number ("APN") 370-140-003-2; and

WHEREAS, the proposed project is regulated as set forth in the Martinez Municipal Code ("MMC") Title 22 "Zoning," establishing permit requirements and Government Code Section 65800, et seq. providing for the administration of local zoning and permitting laws; and

WHEREAS, the Planning Commission held a duly noticed public hearing on June 25, 2024 to consider the application, receive public testimony, and consider all other substantial evidence in the record in compliance with Government Code Section 65091; and

WHEREAS, the proposed project satisfies the requirements of the Protected Open Space and Parks Overlay imposed by Martinez voters when Measure I was approved; and

WHEREAS, the proposed project satisfies the Hillside Development Regulations imposed by MMC Chapter 22.33; and

WHEREAS, proper notice of said hearing was given in all respects as required by law; and

WHEREAS, the Planning Commission determined this project is categorically exempt from the requirements of the California Environmental Quality Act ("CEQA"), pursuant to CEQA Guidelines section 15183 (Projects Consistent with a Community Plan or Zoning), as the project was previously analyzed in the Franklin Hills Specific Plan Environmental Impact Report ("EIR"); and

WHEREAS, the Record of Proceedings ("Record") upon which the Planning Commission bases its decision regarding the planning application includes, but is not limited to: (1) all staff reports, City files and records, and other documents prepared for and/or submitted to the City relating to the application; (2) the evidence, facts, findings, and other determinations set forth in this resolution and the Exhibits attached hereto and incorporated herein; (3) the General Plan 2035 and the MMC; (4) the Franklin Hills

Specific Plan EIR; (5) all designs, plans, studies, data, and correspondence submitted by the Applicant in connection with the planning application; (6) all documentary and oral evidence received at public hearings or submitted to the City relating to the planning application; and (7) all other matters of common knowledge to the Planning Commission including, but not limited to, City, state and federal laws, policies, rules, regulations, reports, records, and projections related to development within the City and its surrounding areas.

NOW THEREFORE, the Planning Commission of the City of Martinez does hereby ordain as follows:

NOW, THEREFORE, BE IT RESOLVED, that the Planning Commission of the City of Martinez does hereby adopt this Resolution approving Planning Application No. 2023-0038, subject to conditions of approval and the project plans, attached hereto as Exhibits B and C respectively, and incorporated herein by reference.

* * * * *

I HEREBY CERTIFY that the foregoing is a true and correct copy of a resolution duly adopted by the Planning Commission of the City of Martinez at a Regular Meeting of said Commission held on the 25th day of June, 2024, by the following vote:

Michael P. Cass, Planning Manager	
ATTEST:	
ATTEOT	
	Sean Trambley, Planning Commission Chair
ABSENT:	
ABSTAIN:	
NOES:	
AYES:	

EXHIBIT A

DESIGN REVIEW FINDINGS

The Planning Commission hereby makes the following findings with respect to Design Review as required by Martinez Municipal Code ("MMC") Section 22.34.045:

A. Complies with all other applicable provisions of the Martinez Municipal Code involving the physical development of buildings, structures, and property, including use restrictions;

The general provisions of Title 22 – Zoning, require orderly development to protect and promote the public health, safety, peace, comfort, convenience, prosperity, and general welfare. The proposed project complies with all residential development standards and other provisions regarding development of new residential dwellings.

B. Provides desirable surroundings for occupants as well as for neighbors. Emphasis is placed upon exterior design with regard to height, bulk, and area openings; breaks in the facade facing on a public or private street; line and pitch of the roof; and arrangement of structures on the parcel;

The subject site is located at a relatively secluded site with no adjacent neighbors. The exterior design of the project, including height, bulk, area openings, breaks in facades, roof pitch, and arrangement of structures is appropriate and harmonious for the overall design. The project's architectural features also create an aesthetically appropriate dwelling for the occupants and surrounding neighbors.

C. Has a harmonious relationship with existing and proposed neighboring developments avoiding both excessive variety and monotonous repetition, but allowing similarity of style, if warranted;

The proposed project is a modern Mediterranean style dwelling that is neither novel nor overrepresented in the immediate vicinity. The subject site is relatively secluded and isolated from neighboring properties due to the topography of the site and large setbacks of approximately 70 and 135 feet; therefore, compatibility with surrounding developments is not a concern.

D. Uses a limited palette of exterior colors; those colors must be harmonious and architecturally compatible with their surrounding environment;

The proposed color palette includes neutral colors that are consistent with the Mediterranean architectural style and compatible with the surrounding environment.

E. Uses a limited number of materials on the exterior face of the building or structure. In addition, all interior surfaces normally visible from public property shall be finished;

The proposed structure utilizes a variety of materials in neutral colors to provide visual interest. Exterior materials include a white smooth stucco; white trim; orange, Spanish-style tile roofing; and black metal railings. No interior surfaces will be visible from public property based on the building pad's location, but nonetheless all surfaces will be finished.

F. Has exterior lighting appropriately designed with respect to convenience, safety, and effect on occupants as well as neighbors;

The proposed project will be required to comply with a condition of approval requiring exterior lighting be directed such that lights create as little off-site glare and nuisance as is feasible. The same condition will require all fixtures to be slare-shielded, also referred to as dark-sky compliant.

G. Effectively conceals work areas, both inside and outside of buildings, in the case of non-residential facilities;

Not applicable since the proposed project will not include any work areas inconsistent with its intended residential use.

H. Undergrounds all utility boxes unless it can be shown that they can be effectively screened from the view of the general public;

The proposed project will be required to comply with a condition of approval requiring all new utility distribution services on-site and off-site be installed underground.

 Designs the type and location of planting with respect to the preservation of specimen and landmark trees, water conservation as set forth in Chapter 22.35, and maintenance of all planting;

The proposed project will be required to comply with a condition of approval requiring efficient irrigation, appropriate landscape design, and proper maintenance to reduce excess irrigation runoff, promote surface filtration, and minimize use of fertilizers, herbicides, and pesticides, consistent with MMC Chapter 22.35. Further, the proposed landscape is required to comply with the State's Model Efficient Landscape Ordinance.

J. Establishes a circulation pattern, parking layout and points of ingress and egress (both vehicular and pedestrian), designed to maximize pedestrian safety and convenience and to minimize traffic congestion resulting from the impediment of vehicular movement. When applicable, access for handicapped individuals should be considered;

Not applicable since the proposed project involves a low-intensity single-family use that typically does not generate a high volume of vehicular or pedestrian traffic.

K. Ensures that all signs be designed so that they are in scale with the subject development, and will not create a traffic hazard. Emphasis is placed upon the identification of the use or building rather than the advertising of same; and

Not applicable since the proposed project is intended for a single-family residential use which only include an address sign, unlike larger multifamily, commercial, and office developments which require additional signage.

L. Substantially preserves views from nearby properties where this can be done without severe or undue restrictions on the use of the site, balancing the property rights of the Applicant and the affected property owner(s)

The proposed project's secluded nature, large setbacks, topography, and surrounding vegetation prevents it from being seen by any adjacent neighbors; therefore, views from nearby properties would be preserved.

EXHIBIT B

CONDITIONS OF APPROVAL

These conditions apply to and constitute Design Review approval for a new single-family dwelling, located at 140 Glendora Drive.

- 1. <u>Duplicate Conditions in Project Plans</u>: The Conditions of Approval will be incorporated as the first or second sheet in the plan set submitted for building permit(s) application.
- Substantial Conformance: The proposed project will be constructed substantially
 in conformance with the plans presented to the Planning Commission on June
 25, 2024. Minor changes may be approved by the Planning Manager or
 designee. All improvements shall be constructed and installed in accordance
 with these approvals. Once constructed or installed, all improvements shall be
 maintained as approved.
- 3. Failure to Conform to Conditions: If the Applicant constructs buildings or makes improvements in accordance with these approvals, but fails to comply with any of the Conditions of Approval or limitations set forth in these Conditions of Approval and does not cure any such failure within a reasonable time after notice from the City, then such failure shall be cause for non-issuance of a certificate of occupancy, revocation or modification of project approvals, or any other remedies available to the City.
- 4. Exterior Lighting: Exterior lighting shall be directed such that lights create as little off-site glare and nuisance as is feasible. All fixtures shall be glare-shielded, also referred to as dark-sky compliant.
- 5. <u>Easement Statement</u>: The Applicant shall revise the project plans to include a statement from the project engineer verifying review of easement descriptions in the title report and the proposed dwelling, retaining walls, or any other structures are not located within any of the specified easements.
- 6. Soils Report: Prior to issuance of a Building Permit, the Applicant shall submit

- an application for a Soils Report Peer Review with the Engineering Division and pay all associated fees.
- 7. <u>Successors in Interest</u>: These Conditions of Approval shall apply to any successor in interest in the property and the Applicant shall be responsible for assuring that the successor in interest is informed of the terms and conditions of this approval.
- 8. <u>Expiration of Approval</u>: The permits and approval shall expire in one year from the date on which they became effective unless the Applicant obtains a building permit and begins construction. The effective date of this planning approval is June 25, 2024.
- 9. Extension of Approval: Extension of the expiration date of a permit or approval can be considered if an application with required fee is filed prior to the expiration date. Extensions are not automatically approved; the Planning Manager or designee may consider changes in conditions, City policies, surrounding neighborhood, and other factors permitted to be considered under the law when evaluating the continuation request.
- 10. <u>Relevant Ordinances and Regulations</u>: Nothing contained herein shall be construed to permit any violation of relevant regulations of the City, or other public agency having jurisdiction.
- 11. Fees and Deposits: All fees, bonds, and deposits required by City and other agencies having jurisdiction shall be paid prior to City approval of the Building Division. Prior to approval of the plans and issuance of permits, the Applicant shall pay all applicable fees and deposits including, but not limited to, plan check, inspection, drainage, and development impact mitigation fees. The actual fees shall be in accordance with the City's fee schedule in effect at the time of payment.
- 12. <u>Indemnification</u>: The Applicant shall defend, indemnify, and hold harmless the City and its agents, officers, attorneys, and employees from any claim, action, or

proceeding brought against the City or its agents, officers, attorneys, or employees to attack, set aside, void, or annul the Planning Commission's decision to approve the application and any environmental document approved in connection therewith. This indemnification shall include damages or fees awarded against the City, if any, cost of suit, attorneys' fees, and other costs and expenses incurred in connection with such action whether incurred by the Applicant, the City, and/or the parties initiating or bringing such action.

- 13. Notification Claims/Actions: The City shall promptly notify the Applicant of any claim, action, or proceeding, which may be filed and shall cooperate fully in the defense, as provided for in Government Code Section 66474.9. In the event the Applicant is required to defend the City in connection with any said claim, action, or proceeding, the City shall retain the right to: (i) approve the counsel to so defend the City; (ii) approve all significant decisions concerning the manner in which the defense is conducted; and (iii) approve any and all settlements, which approval shall not unreasonably be withheld. The City shall also have the right not to participate in said defense, except that the City agrees to cooperate with the Applicant in the defense of said claim, action or proceeding. If the City chooses to have counsel of its own to defend any claim, action or proceeding, and the Applicant has already retained counsel to defend the City in such matters, the fees and expenses of the counsel selected by the City shall be paid by the City, except that the fees and expenses of the City Attorney shall be paid by the Applicant.
- 14. Notification of Fees, Dedications, Reservations, and Exactions: The Conditions of Approval set forth herein include certain fees, dedication requirements, reservation requirement, and other exactions. Pursuant to Government Code Section 66020(d)(1), these Conditions constitute written notice of a statement of the amount of such fees, and a description of the dedications, reservations, and other exactions which may or may not be subject to the Mitigation Fee Act (Government Code Section 6000, et seq.). The Applicant is hereby further notified that the 90-day approval period in which the Applicant may protest these

fees, dedications, reservations, and other exactions, pursuant to Government Code Section 66020(a), has begun. If the Applicant fails to file a protest within this 90-day period complying with all the requirements of Government Code Section 66020, the Applicant will be legally barred from later challenging such exactions.

- 15. <u>Electrical and Mechanical Equipment</u>: The Applicant shall submit plans for added electrical and mechanical equipment to the Building Division prior to commencement of work.
- 16. <u>Building Codes</u>: Construction shall comply with all applicable City and State building codes and requirements.

17. Conditions for Construction Activity:

a. Noise Control and Work Hours: All construction activities shall conform to the Martinez Municipal Code Chapter 8.34 (Noise Control). Construction activities on private property are limited to the hours of 7:00 a.m. to 7:00 p.m., Monday through Friday; and 9:00 a.m. to 5:00 p.m. Saturday and Sunday. The permittee shall post a sign on the site notifying all workers of these restrictions.

Construction activities on public property shall be limited to the hours stipulated in the encroachment permit if one is required.

- b. <u>Quiet Equipment</u>: Contractor shall be required to employ the quietest construction equipment available, and to muffle noise from construction equipment and to keep all mufflers in good working order in accordance with State law.
- c. <u>Dust Control</u>: Adequate dust control measures shall always be employed, including weekends and holidays, and throughout all grading and construction periods. The Applicant shall regularly water areas that are exposed for extended periods to reduce wind erosion. Measures to be incorporated may include, but are not limited to, the following: keeping dust on the site, use of

water trucks or sprinkler systems to prevent dust from leaving the site and to create a crust after the completion of each day's activities, use of water trucks or sprinkler systems to keep all areas of vehicle movement damp enough to prevent dust from leaving the site, wetting down the construction area after work is completed for the day and whenever winds exceed 15 mph, having site watered at least once each day including weekends and/or holidays when winds exceed 15 mph, and covering soil stockpiled for more than two days or treating with soil binders to prevent dust generation.

The Applicant shall consider using recycled water for dust control, soil compaction, and plant establishment, as part of the Central Contra Costa Sanitary District's Commercial Recycled Water Truck Fill Program, which is free of charge for the first 100,000 gallons. The automated commercial truck fill station is located off Imhoff Drive in Martinez, on the opposite side of the street from 5501 Imhoff Drive.

- d. <u>Streets Clear of Debris</u>: The Contractor shall ensure that surrounding streets stay free and clear of silt, dirt, dust, tracked mud, and other debris coming in from or in any way related to project construction. Paved areas and access roads shall be swept on a regular basis. All trucks shall be covered.
- Equipment Speed: Speeds of construction equipment shall be limited to 10 miles per hour on site and 15 miles per hour on adjacent public right-of-ways.
 This includes equipment traveling on local streets to and from the site.
- f. <u>Driveway Access</u>: Access shall always be maintained to all driveways.
- g. <u>Parking on Surrounding Streets</u>: There shall be no construction vehicles or equipment parking on the surrounding residential streets, including all workers vehicles, except if an encroachment permit is issued by the City.
- h. <u>Truck Routes</u>: Truck routes for the import or export of cut/fill material shall be identified and approved by the City Engineer or designee prior to the issuance

of any permits.

 Property Damage: The Applicant shall be responsible for the repair of any damage to public streets caused by the import or export of soils materials necessary for the project, prior to final inspection.

18. Fees and Deposits:

- a. All required fees and security deposits required by the City shall be submitted prior to approval of the plans and issuance of the Building, Encroachment, Grading, or Site Development Permit, whichever comes first. Security deposit(s) shall be refunded after the project is complete and accepted by the City. The actual fees shall be determined per the City's fee schedule at the time of payment.
- b. The Applicant shall pay all applicable fees and security deposits including, but not limited to, plan check, inspection, drainage fee (either City or Contra Costa Flood Control District and Water Conservation District, depending on project location), and development impact mitigation fees. The actual fees shall be in accordance with the City's User Fee Schedule in effect at the time of payment.
- c. All fees and deposits required by other agencies having jurisdiction shall be paid prior to City approval of the Plans or issuance of the Site Development or Building Permit, whichever comes first.
- 19. <u>Site Improvement Plans</u>: The Site Improvement Plans are subject to review and approval by the City Engineer or designee and shall include the following:
 - a. <u>Runoff</u>: Site Improvement Plans shall demonstrate that runoff that is collected and conveyed (including runoff from the slope above the proposed dwelling) to adequate downstream facilities with no diversion.

- b. <u>Driveway Improvements</u>: Provide curb and gutter on south side of the driveway to collect runoff and show the curb and gutter for the driveway on a typical section.
- c. <u>Driveway Profile</u>: The maximum driveway slope, from the garage's finished floor is 10 percent for a minimum distance of 10 feet.
- d. <u>Finished Grade</u>: The on-site finish grading shall require drainage to be directed away from all building foundations at a minimum slope of two percent to a maximum slope of 20 percent and shall be directed towards approved drainage facilities or swales. Non-paved drainage swales shall have a minimum slope of one percent. Unless otherwise approved by the City, the Applicant shall provide a minimum four-foot wide clear access around the building.
- e. <u>Natural Contours</u>: Contour grading techniques with spot elevations shall be employed throughout the project to achieve a more natural appearance, even where this will increase the amount of grading. Tops of cuts or toes of fills adjacent to existing public rights-of-way or easements shall be set back two feet minimum from said rights-of-way and easements.
- f. <u>Erosion Control</u>: Erosion control measures shall be implemented per plans approved by the City Engineer or designee for all grading activities between October 1st and April 15th. All graded slopes exceeding five feet in height shall be hydroseeded or landscaped no later than September 15th and irrigated (if necessary) to ensure establishment prior to the onset of the rainy season.
- g. <u>Grading on Adjacent Properties</u>: Any grading or work on adjacent properties will require written approval of those property owners potentially affected.
- h. <u>Cultural Resources</u>: If cultural resources are discovered during subsurface excavations, the Contractor shall cease construction, obtain authorization from the Planning Manager or designee, and shall implement the

- recommendations and mitigation measured suggested by a qualified archeologist prior to continuing excavation or grading activities.
- i. <u>Boundary Treatment</u>: The plans shall include the boundary treatment shown on cross sections, drawn to scale, for retaining walls, fencing, and drainage.
- j. <u>Easements and Right-of-Way</u>: No structure(s) shall be constructed within the right-of-way or over existing easements(s).
- k. <u>Underground Utilities</u>: All new utility distribution services on-site and off-site shall be installed underground.
- I. <u>Frontage Improvement</u>: Pursuant to Martinez Municipal Code Chapter 12.30, damaged street pavement along the frontage of the property shall be constructed or replaced to center line of the street (on Glendora Drive) to the satisfaction of the City Engineer or designee, even if the pavement is damaged prior to construction.
- m. <u>Damage to Right-of-Way</u>: Damages to improvements within the public right-of-way as a result of the construction operations shall be restored to its condition prior to construction, or replaced to the satisfaction of the City Engineer or designee.
- n. <u>Driveway</u>: The driveway shall be contained and constructed along the frontage of the property. No part of the driveway shall be allowed on adjacent property or adversely impact existing driveways. The driveway profile shall conform to City Standard Detail# CC203. The driveway plan and profile shall be shown on the improvement plans. The plan and profile shall be subject to the City Engineer or designee's approval.
- o. <u>Trees</u>: Existing trees shall be shown on the grading plan. Trees to be removed shall be clearly noted on the plans.
- p. Neighboring Properties: Any work on adjacent properties will require written

approval of those property owners potentially affected.

20. <u>Utilities Services</u>:

 a. <u>Undergrounding</u>: All new utility distribution services on-site and off-site shall be installed underground.

b. Water System:

- I. <u>Flow Requirements</u>: The subject site is located within the City water service area. The water system shall be designed and constructed to meet the requirements of the City water service agency, and the fire flow requirements of the Contra Costa County Fire Protection District.
- II. <u>Water Service Standards</u>: Water system connection, including installation of the water meter, shall be made in accordance with the City's water service agency standards. Prior to obtaining water service, all required water fees shall be paid in accordance with the water fee schedule in effect at time of payment.
- III. <u>Backflow Prevention</u>: Backflow prevention device, required as part of the water service installation, must be completed before occupancy of the building.

c. Sanitary Sewer:

- Standard Detail and Specifications: The site is within Central Contra Costa Sanitary District ("CCCSD") service area. The sewer system shall be designed and constructed in accordance with CCCSD standard details, specifications, and requirements.
- II. <u>Placement of Private Sewer Lateral</u>: No private sewer lateral shall be installed along the street right-of-way.

- III. <u>CCCSD Permit Required</u>: CCCSD permit is required prior to City issuing a Site Development or Encroachment Permit.
- 21. <u>Weed Abatement</u>: The Applicant shall cut down and remove all weeds, grass, vines, or other growth that is capable of being ignited and endangering property to the satisfaction of the City Engineer or designee and the Contra Costa County Fire Protection District.
- 22. <u>Retaining Walls</u>: The Applicant shall obtain a Building Permit(s) for retaining walls, as required by the Building Code.

23. Storm Drain:

- d. <u>Stormwater Collection</u>: The Applicant shall collect and convey storm water runoff to existing drainage system, adequate storm drain facilities, or natural defined water course, to the satisfaction of the City Engineer or designee.
- e. <u>City Criteria</u>: The storm drain system shall be designed per City standards criteria.
- f. Stormwater Runoff to Adjacent Lots: The Applicant shall not increase storm water runoff to adjacent downhill lots unless either: (1) a Drainage Release is signed by the property owner(s) of potentially affected downhill lots and recorded in the office of the County Recorder; or (2) site drainage is collected and conveyed in approved adequate drainage facilities within a private drainage easement through a downhill property. This condition may require collection of on-site runoff and construction of an off-site storm drainage system. All required releases and/or easements shall be obtained prior to issuance of the Building, Encroachment, Grading or Site Development Permit, whichever comes first.

24. National Pollutant Discharge Elimination System (NPDES):

a. Clarifications in Project Plans and Stormwater Control Plan: The surface

calculation table shown on Sheet C-2 of the project plans, provided as Exhibit C, shall be revised to resolve any inconsistencies between the plans and the Stormwater Control Plan. The project's impervious surface area should include all new areas and removed and replaces areas of the driveway. All impervious and pervious pavement surfaces shall be shown on the drainage area map of the Stormwater Control Plan.

- b. <u>General</u>: The Applicant shall comply with all rules, regulations, and procedures of the NPDES as per the California Regional Water Quality Control Board, San Francisco Bay Region, Municipal Regional Stormwater Permit ("MRP"); and the City's Stormwater Management regulations.
- c. <u>C.3 Guidebook</u>: If the project creates and/or replaces impervious surface area equal to or greater than 2,500 square feet, then the Applicant shall submit a Stormwater Control Plan as per the recent edition of the Contra Costa County Clean Water Program ("CCCWP") C.3 Guidebook for small project requirements.
- d. <u>Impervious Surfaces</u>: Minimize the amount of impervious surface area to the satisfaction of the City Engineer or designee.
- e. <u>Landscape and Irrigation</u>: Efficient irrigation, appropriate landscape design, and proper maintenance shall be implemented to reduce excess irrigation runoff, promote surface filtration, and minimize use of fertilizers, herbicides, and pesticides.

25. General Requirements:

- a. <u>Building Codes</u>: Construction shall comply with all applicable City and State building codes and requirements including handicapped requirements, energy conservation requirements, grading regulations, and erosion control regulations.
- b. <u>Design Standards and Specifications</u>: Design of all public improvements

- shall conform to the City's Design Guidelines, Standard Special Provisions, and Standard Drawings. Prior to preparation of improvement plans, the developer or their representative should contact the Engineering Division.
- c. <u>Fees, Agreements, and Plans</u>: Prior to City approval of the Plans, all required fees and deposits shall be paid, all agreements shall be executed, and all grading and improvement plans shall be approved by the City Engineer and Community and Economic Development Director or designee(s). No construction shall take place until the issuance of the appropriate Encroachment, Site, Grading, and/or Building Permits.
- d. Grading, Site, and Improvement Plans: Complete grading, site and improvement plans, specifications and calculations shall be submitted to and approved by the City Engineer, Community and Economic Development Director, and/or other agencies having jurisdiction over improvements within the proposed development prior to issuance of a Building, Site, Grading, and/or Encroachment Permit whichever comes first. Approved plans shall become the property of the City upon being signed by the City Engineer and Community and Economic Development Director or designee(s).
- e. <u>All-Weather Surface and Fire Hydrants</u>: Prior to issuance of the Building Permit, the access to building sites shall be graded and improved to at least an all-weather surface condition, and operating fire hydrants shall be in place.
- f. <u>Encroachment Permit and Site Development Permit</u>: The Applicant shall obtain an Encroachment Permit from the Engineering Division for any work within the City right-of-way. The Applicant shall obtain a Site Development Permit from the Engineering Division for work onsite.
- g. Other Agencies Approval: Approval by the CCCSD, the Contra Costa County Fire Protection District, and the water agency of all improvements is

- required prior to City approval of construction plans.
- h. <u>Solar System Required</u>: Applicant is required to install a solar photovoltaic system that complies with the requirements listed in the California Building Energy Efficiency Standards.
- 26. Approved Plans: Complete grading plan, site development plans, erosion control plan, specifications and calculations shall be submitted to and approved by the City Engineer, the Community and Economic Development Director, and/or other agencies having jurisdiction over all improvements within the proposed development prior to issuance of a Building, Site, Grading, or Encroachment Permit, whichever comes first. Approved plans shall become the property of the City upon being signed by the City Engineer and Community and Economic Development Director or designee(s).
- 27. <u>Address Assignment</u>: The Applicant shall submit an address assignment application, along with the required application fee, for the new residence prior to issuance of a building permit.
- 28. <u>Planning Final Inspection</u>: A final inspection by the Planning Division is required, prior to issuance of certificate of occupancy. Contact the Planning Division at least two weeks prior to Occupancy, to request a site inspection of all exterior improvements including buildings, driveways, parking lots, landscaping, irrigation, lighting, and walls.

29. Contra Costa County Fire Protection District Conditions:

a. <u>Access Requirements</u>: Modify plans to clearly state the concrete driveway will be designed to support a minimum of 37 tons for fire apparatus and be constructed with grooved concrete, per Fire Protection District standards, in all areas exceeding 16 percent slope. The project engineer shall confirm the proposed permeable concrete design will support the required load in a letter with a stamp.

- b. <u>Grade</u>: Plans should show which sections of the driveway and access road exceed 16 percent clearly.
- c. <u>WUI Area</u>: Project located in a Very High Fire Severity Zone. Please note that Chapter 7A of the building for building in a Wildland Urban Interface ("WUI") area shall apply.
- d. <u>Access Roadways</u>: Access roadways of less than 28-feet unobstructed width shall have signs posted or cubs painted red with the words: "NO PARKING FIRE LANE" clearly marked. (22500.1) CVC, (503.3) CFC
 - Access roadways of 28 feet or greater, but less than 36-feet unobstructed width shall have "NO PARKING FIRE LANE" signs posted, allowing for parking on one side only or curbs painted red with the words "NO PARKING FIRE LANE" clearly marked. (22500.1) CVC, (503.3) CFC
- e. <u>Turnaround</u>: The project as proposed shall require the installation of an approved Fire Protection District turnaround. Dead-end emergency apparatus access roadways exceeding 150 feet in length shall be provided with approved provisions for the turning around of Fire Protection District apparatus. Contact the Fire Protection District for approved designs. (503.2.5) CFC
- f. Access Gate: Access gate for the Fire Protection District apparatus shall be a minimum of 16 feet wide. Access gates shall slide horizontally or swing inward and shall be located a minimum of 30 feet from the street. Electrically operated gates shall be equipped with a Knox Company key-operated switch. Manually operated gates shall be equipped with a non-casehardened lock or approved Fire Protection District lock. Contact the Fire Protection District for information on ordering the key-operated switch. (D103.5) CFC.
- g. Water Supply: The Applicant shall provide an adequate and reliable water supply for fire protection as set forth in the California Fire Code. (507.1)

CFC

- h. Minimum Flow: The Applicant shall provide an adequate and reliable water supply for fire protection with a minimum fire flow of 875 GPM. Required flow must be delivered from not more than one hydrant flowing simultaneously for a duration of 120 minutes while maintaining 20-pounds residual pressure in the main. (507.1), (B105) CFC
- i. <u>Land Development Permit Required</u>: A land development permit from the Fire Protection District is required for access and water supply review and approval prior to submitting building construction plans. The Applicant shall submit a minimum of two copies of full size, scaled site improvement plans indicating:
 - I. All existing or proposed hydrant locations
 - II. Fire apparatus access to include slope and road surface
 - III. Elevations of building
 - IV. Size of building and type of construction
 - V. Gates, fences, retaining walls, bio-retention basins, any obstructions to access
 - VI. Detail showing the lowest level of fire department vehicle access and the floor level of the highest occupied floor
 - VII. Striping and signage plan to include "NO PARKING-FIRE LANE" markings

This is a separate submittal from the building construction plans. These plans shall be approved prior to submitting building plans for review. (501.3) CFC

j. Emergency Access Roadways and Hydrants: Emergency apparatus access

roadways and hydrants shall be installed, in service and inspected by the Fire Protection District prior to construction or combustible storage on site. (501.4) CFC (Note: A temporary aggregate base or asphalt grindings roadway is not considered an all-weather surface for emergency apparatus access. The first lift of asphalt concrete paving shall be installed as the minimum roadway material and must be engineered to support the designated gross vehicle weight of 37 tons.)

- k. Automatic Fire Sprinkler System Required: The dwelling as proposed shall be protected with an approved automatic fire sprinkler system complying with the 2016 edition of NFPA 130 or Section R313.3 of the 2022 California Residential Code. Submit a minimum of two (2) sets of plans to Fire Protection District office for review and approval prior to installation. (903.2) CFC, (R313.3) CRC, Contra Costa County General Plan/ Contra Costa County Ordinance 2019-37.
- Combustible Liquid Storage Tanks Prohibited: Flammable or combustible liquid storage tanks shall not be located on the site without obtaining approval and necessary permits from the Fire Protection District. (3401.4) CFC
- m. Removal of Flammable Plant Material: The owner shall cut down and remove all weeds, grass, vines, or other growth that is capable of being ignited and endangering property. (304.1.2) CFC
- n. <u>Fire Protection District Review</u>: Plans shall be submitted to the Fire Protection District for review and approval prior to construction of the building or installation of the systems to ensure compliance with minimum requirements related to fire and life safety. Plan review and inspection fees shall be submitted at the time of plan review submittal. (105.4.1) CFC, (901.2) CFC, (107) CBC
- o. Preliminary Review Only: Preliminary review comments shall not be

construed to encompass the complete project. Additional plans and specifications may be required after further review.

EXHIBIT C PROJECT PLANS

[see following sheets]

SITE PLAN NOTES 1. DEMOLITION CONTRACTOR SHALL RELOCATE REUSABLE MATERIALS TO DESIGNATED SALVAGE AREA. NON-USABLE MATERIALS SHALL BE PLACED APPROPRIATELY IN REFUSE BIN AND SHALL BE COVERED AT NIGHT AND DURING RELATIVE HIGH WINDS, RAIN, ETC...REFUSE BIN SHALL BE COVERED DURING TRANSFER TO AND FROM DUMP SITE, CONTRACTOR TO BE LIABLE FOR REFUSE SPILLING. ALL DEBRIS TO BE HAULED AWAY AND CLEAN-UP SHALL BE COMPLETED TO BROOM FINISH. EXISTING MATERIALS AND/OR STRUCTURE TO REMAIN SHALL BE PROTECTED FROM DUST, PAINT CHIPPING, ETC..., BY USE OF PLASTIC OR WHATEVER IS REQUIRED FOR PROPER PROTECTION. EXISTING STRUCTURES SHALL HAVE BRACING AND SHORING AS REQUIRED TO PROTECT THE EXISTING STRUCTURE. PROVIDE DE-WATERING FACILITIES FOR CONSTRUCTION AS REQUIRED. COORDINATE AS-BUILT INFORMATION, STRUCTURAL, ETC. TO DESIGNER/ENGINEER AS 2. THE DISCHARGE OF POLLUTANTS TO ANY STORM DRAINAGE

SYSTEM IS PROHIBITED. NO SOID WASTE, PETROLEUM BYPRODUCTS, SOIL PARTICULATE, CONSTRUCTION WASTE MATERIALS, OR WASTEWATER GENERATED ON CONSTRUCTION SITES OR BY CONSTRUCTION ACTIVITIES SHALL BE PLACED, CONVEYED OR DISCHARGED INTO THE STREET, GUTTER OR STORM DRAIN SYSTEM.

3. THE CONSTRUCTION SHALL NOT RESTRICT A FIVE-FOOTCLEAR AND UNOBSTRUCTED ACCESS TO ANY WATER OR POWER DISTRIBUTION FACILITIES (POWER POLES, PULLBOXES, TRANSFORMERS, VAULTS, PUMPS, VALVES, METERS, PPURTENANCES, ETC.) OR TO THE LOCATION OF THE HOOK-UP. THE CONSTRUCTION SHALL NOT BE WITHIN TEN FEET OF ANY POWER LINES WHETHER OR NOT THE LINES ARE LOCATED ON THE PROPERTY. FAILURE TO COMPLY MAY CAUSE CONSTRUCTION DELAYS AND/OR ADDITIONAL

4. PROVIDE LIGHTED HOUSE NUMBERS AT DRIVEWAY ENTRANCE COMPLYING WITH MARTINEZ MUNICIPAL CODE

5. ALL NEW UTILITY SERVICES SHALL BE PLACED

VICINITY MAP

PARKING REQUIREMENT

2 STALLS

2 STALLS (PROVIDED: 3)

TOTAL PARKING REQUIRED

(N) MAIN HOUSE:

TOTAL:

MAIN SEWER ON GLENDORA DR

1. THE CONSTRUCTION SHALL NOT RESTRICT A FIVE-FOOT CLEAR AND UNOBSTRUCTED ACCESS TO ANY WATER OR POWER DISTRIBUTION FACILITIES (POWER POLES, PULL-BOXES. TRANSFORMERS, VAULTS, PUMPS, VALVES, METERS, ETC) OR TO THE LOCATION OF THE HOOK-UP, THE CONSTRUCTION SHALL NOT BE WITHIN TEN FEET OF ANY POWER LINES-WHETHER OR NOT THE LINES ARE LOCATED ON THE PROPERTY. FAILURE TO COMPLY MAY CAUSE CONSTRUCTION DELAYS AND/ OR ADDITIONAL EXPENSES.

GENERAL NOTES

2. AN APPROVED SEISMIC GAS SHUTOFF VALVE WILL BE INSTALLED ON THE FUEL GAS LINE ON THE DOWN STREAM SIDE OF THE UTILITY METER AND BE RIGIDLY CONNECTED TO THE EXTERIOR OF THE BUILDING OR STRUCTURE CONTAINING THE FUEL GAS PIPING. 3. PROVIDE LOW CONSUMPTION WATER CLOSETS FOR ALL NEW CONSTRUCTION. EXISTING SHOWER HEADS AND TOILETS MUST BE ADAPTED FOR LOW WATER CONSUMPTION. 4. PROVIDE 72" HIGH NON-ABSORBENT WALL ADJACENT TO SHOWER AND APPROVED

SHATTER-RESISTANT MATERIALS FOR SHOWER ENCLOSURE. 5. ALL CONSTRUCTION WASTE AND DEBRIS MUST BE CONTAINERIZED AT ALL TIMES 6. FINAL APPROVAL REQUIRED BY THE PUBLIC WORKS DEPARTMENT FOR STREET IMPROVEMENTS, CURB CORES, CURB/GUTTERS, ETC. SEPARATE PUBLIC WORKS PERMIT REQUIRED FOR DRIVEWAYS, APPROACH TO DRIVEWAY, SEWER LATERALS AND ANY WORK

IN RIGHT OF WAY. 7. ALL CONSTRUCTION SHALL COMPLY WITH ALL APPLICABLE FEDERAL, STATE AND LOCAL CODES AND AMENDMENTS. 8. A SURVEY SHALL BE PROVIDED BY A LICENSED SURVEYOR ON STRUCTURES WHICH DEFINE PROPERTY LINES, SET BACKS, DESIGNATED PARKLAND OR STREET RIGHT-OF-WAY. 9. DUST CONTROL MEASURES SHALL BE MAINTAINED THROUGHOUT THE DURATION OF THE 10. WATER HEATER MUST BE STRAPPED TO WALL.

11. PROVIDE ULTRA FLUSH WATER CLOSETS FOR ALL NEW CONSTRUCTION. EXISTING SHOWER HEADS AND TOILETS MUST BE ADAPTED FOR WATER CONSUMPTION. 12. LAG BOLTS: PROVIDE LEAD HOLE 40%-70% OF THREADED SHANK DIA. AND FULL DIA. FOR SMOOTH SHANK PORTION. 91 NDS 13. BLOCKING. ROOF RAFTERS AND CEILING JOINTS SHALL BE SUPPORTED LATERALLY TO PREVENT ROTATION & LATERAL DISPLACEMENT IN ACCORDANCE w/ THE PROVISIONS OF

14. CONTRACTOR AND/OR OWNER SHALL VERIFY CONSTRUCTION SITE TO CONFIRM THAT

THERE IS NO TRACEOF DEMOLISHED SWIMMING POOL WITHIN 5 FT FROM PROPOSED

PERIMETER OF THE CONSTRUCTION SITE. OTHERWISE, THEY NEED TO SUBMIT SOIL COMPACTION REPORT FROM LICENSED SOIL ENGINEER TO BUILDING INSPECTOR PRIOR TO FOUNDATION INSPECTION. 15. SHEARWALLS, LATHING & PLASTER IN MATERIALS SHALL CONFORM TO THE STANDARD LISTED IN CH.6 & CH.7 CRC 16. ALL BOLT HOLES SHALL BE DRILLED 1/32" TO 1/16" OVERSIZED. "ENGINEER" MUST INCLUDE IN STRUCTURAL OBSERVATION NOTES.

17. PROVIDE RAIN GUTTERS AND CONVEY RAIN WATER TO THE STREET. 18. CONCRETE 3000PSI

19. PARALLEL BEAM E.2.0 PSL 20. UFER GROUND IS REQUIRED AT NEW ELECTRICAL SERVICE. 21. UNDERGROUND UTILITIES REQUIRED ON SITE PLAN AND SHOW FOR ELECTRICAL, CABLE TV. AND

22. ARC FAULT CIRCUIT INTERRUPTION PROTECTION IS REQUIRED FOR ALL BRANCH CIRCUITS PER 2019 CRC210.12 SHALL BE AFCI PROTECTED 23. BATHROOMS, KITCHEN, GARAGE & OUTSIDE OUTLETS WILL BE GFCI PROTECTED RECEPTACLE OUTLETS. 24. WATER SAVING WATER CLOSET w/1.28 GALLONS PER FLUSH. 25. PROVIDE MECHANICAL VENTILATION FOR BATHROOMS AND LAUNDRY ROOMS WITHOUT OPENABLE

26. GLAZING WHICH IS LESS THAN 60 INCHES FROM A FLOOR AND WITHIN A 24" ARC OF A DOORWAY'S VERTICAL EDGE MUST COMPLY WITH CH.3 CRC 27. LANDINGS AT DOOR. LANDINGS SHALL HAVE A WIDTH NOT LESS THAN THE WIDTH OF THE STAIRWAY OR THE DOOR, WHICHEVER IS GREATER.

28. EVERY SPACE INTENDED FOR HUMAN OCCUPANCY SHALL BE PROVIDED WITH A NATURAL LIGHT IN ACCORDANCE WITH SECTION R303.1 OR SHALL BE PROVIDE AN AVERAGE ILLUMINATION OF 6 FEET-CANDLES OVER THE AREA OF THE ROOM AT A HEIGHT OF 30" ABOVE THE FLOOR LEVEL. 29. THE CONTRACTOR SHALL EXAMINE AND BECOME FAMILIAR WITH ALL CONTRACT DOCUMENTS. SURVEY THE PROPERTY AND BECOME FAMILIAR WITH THE EXISTING CONDITIONS AND SCOPE OF WORK. ALL COST SUBMITTED SHALL BE BASED ON A THROUGH KNOWLEDGE OF ALL WORK AND MATERIALS REQUIRED. ANY DISCREPANCY AND/OR UNCERTAINTY AS TO WHAT MATERIALS OR PRODUCT IS TO BE USED SHOULD BE

VERIFIED WITH THE OWNER OR ENGINEER OF RECORD. 30. DO NOT SCALE DRAWINGS. WRITTEN DIMENSIONS TAKE PRECEDENCE OVER SCALE. RV2_CLOUD4a#_02182024 31. IN THE EVENT A DISCREPANCY IS FOUND IN THE CONTRACT DOCUMENTS, THE OWNER AND THE DESIGNER/ENGINEERS SHALL BE NOTIFIED, IN WRITING, IMMEDIATELY.

32. FIRE SPRINKLER SYSTEM SHALL BE APPROVED BY OCFA AND AN APPROVED PLANS SHALL BE INCLUDED IN THE CONSTRUCTION PACKAGE PRIOR TO BUILDING PERMIT ISSUANCE. 33. VERIFY WITH AQMD FOR ASBESTOS REMOVAL PROCEDURE AND SUBMIT ASBESTOS REPORT TO BUILDING DIVISION PRIOR TO DEMOLITION PERMIT ISSUANCE. 34. TRUSS PACKAGE WITH AN APPROVED STAMP FROM THE ENGINEER OF RECORD SHALL BE SUBMITTED TO THE CITY FOR APPROVAL PRIOR TO BUILDING PERMIT ISSUANCE. 35. LINE AND GRADE CERTIFICATE SHALL BE SUBMITTED TO THE BUILDING INSPECTOR PRIOR TO FOUNDATION

36. SOIL COMPACTION REPORT IS REQUIRED FOR ALL NEW SFD HOUSE OR ADU AT THE TIME OF FOUNDATION 37. WHEN SOLAR PANEL IS REQUIRED, SOLAR PLANS SHALL BE REVIEWED AND APPROVED BY BUILDING DIVISION PRIOR TO ROOF SHEATHING INSPECTION.

PROJECT DATA SHEET INDEX

01-ARCHITECTURE **JURISDICTION HAVING AUTHORITY:** CITY OF MARTINEZ, CA 94553 A0 COVER PAGE ASSESSORS PARCEL NO. APN: 370-140-003 A0.1 EXISTING SITE PLAN **CONSTRUCTION TYPE:** A0.2 DEVELOPMENT PLAN ECD-R-40 **OCCUPANCY GROUP:** R3/U1 SLOPE AND HAZARD AREA MAP A1 PARTIAL SITE PLAN **NUMBER OF STORIES:** 2 STORY A1.1 PARTIAL LANDSCAPE 25'-0", (ALLOWABLE: 25 FT) A1.2 TOPOGRAPHY SITE PLAN A1.3 FIRE DESIGN PLAN A2.0 1ST FLOOR PLAN

A2.1 2ND FLOOR PLAN

AD.10 ARCHITECTURAL DETAILS

SECTIONS & DETAILS

TITLE SHEET

A2.2 ROOF PLAN
A3 ELEVATIONS

A3.1 ELEVATIONS

A4 SECTIONS

C-1

BUILDING MAX HEIGHT: (THE PROJECT IS LOCATED WITHIN THE PROTECTED OPEN SPACE AND PARKS(POPO)) REQUIRED SETBACKS: 25 FT REAR: 25 FT

SETBACKS INDICATE REQUIRED MINIMUM DISTANCE FROM PROPERTY LOT SIZE : OPEN SPACE: 436907 SF 433486 SF

ZONING:

SPRINKLERS:

(E) IMPERVIOUS SURFACE AREA 9071 SF (N) 1ST FLOOR LIVING AREA 1353 SF (N) GARAGE AREA 845 SF (N) FRONT YARD (N) 2ND FLOOR LIVING AREA 2522 SF (N) 2ND UNCOVERED PATIO

(N) 1ST FLOOR FOOTAGE (N) IMPERVIOUS SURFACE AREA 4314 SF (INCLUDING BUILDING AND OUTDOOR STAIRS FOOTPRINT)

MAXIMUM LOT COVERAGE: OVERALL LOT COVERAGE: 2445 SF / 436,907 SF = 0.6% OK

A5 DOOR/WINDOW ELEVATION & SCHEDULE STORMWATER CONTROL PLAN1 A6.1 STORMWATER CONTROL PLAN2 PRECISE GRADING & DRAINAGE PLAN C-4 EROSION & SEDIMENT CONTROL PLAN C-5 EROSION & SEDIMENT CONTROL DETAILS

SCOPE OF WORK

NEW TWO-STORY HOUSE. INCLUDING: 1ST FLOOR:1353 SQ. FT. (TWO BEDROOMS AND ONE BATHROOM) 3-CAR GARAGE:845 SQ. FT. 2ND FLOOR: 2522 SQ. FT. (THREE BEDROOMS, TWO

APPLICABLE CODE

SITE PLAN KEYNOTE

3 (N) ELECTRIC METER AND 200 AMPS MAIN PANEL

Distence Line From Existing Fire Hydrant To The New House Is 552 Feet.

BATHROOMS, ONE LIVING ROOM, ONE DINING ROOM AND ONE KITCHEN)

LEGAL JURISDICTION: CITY OF MARTINEZ. CA

PHONE: (510)909-1933

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CHIEF ENGINEER:LEI ZHENG (MASON)

EMAIL: ENGINEER.LEI@GMAIL.COM

REV.	DESCRIPTION	DATE
0	APPLY FOR PERMITS	07/03/23
1	1ST PLAN CHECK	09/27/2023
2	2ND PLAN CHECK	01/10/2024

Jurisdiction:



SHEET TITLE:

COVER PAGE

SHEET NUMBER:

RV2_CLOUD5f#_02182024 (E) Fire Hydrant 552 feet from new house. The fire flow is 1149 GPM by fire ATTN: DIAZJOEL@LIVE.COM CCCFPD NO.: 2024-00128 protection district. RESIDUAL 27 GPM 1149 MAIN SIZE WATER DISTRICT HYDRANT ELEVATION RV2_CLOUD5a#_02182024 If you have any questions, please contact the undersigned Joe Burgueno 2024.01.31 07:51:36-08'00' JOE BURGUENO (925) 941-3300 RV2_CLOUD1f#_02182024 RV2_CLOUD1a#_02182024 (E) Public Sanitary NOTE: Contact the local water district for detector check valve and backflow prevention requirements. All such devices shall be shown on underground plans and included in sprinkler calculations. *All sprinkler calculations shall be done in the HASS format or similar* 4005 Port Chicago Highway • Concord, California 94520 • Telephone (925) 941-3300 • Fax (925) 941-330 st County • Telephone (925) 757-1303 • Fax (925) 941-3329 West County • Telephone (510) 374-7070 www.cccfpd.org RV2_CLOUD4f#_02182024 PL 20.16'

PROJECT INFORMATION

OWNER: Joel Diaz PHONE: 707-333-4049 Diazjoel@live.com EMAIL: DESIGNER: LEI ZHENG COMPANY: **CECILIA HOME**

PHONE: (510) 909-1933 ENGINEER.LEI@GMAIL.COM EMAIL:

PROFESSIONAL ENGINEER: LEI ZHENG COMPANY: **CECILIA HOME** PHONE: (510) 909-1933 EMAIL:

THIS PROJECT SHALL COMPLY WITH THE 2022 CALIFORNIA RESIDENTIAL CODE 2022 CALIFORNIA PLUMBING CODE 2022 CALIFORNIA MECHANICAL CODE 2022 CALIFORNIA ENERGY CODE 2022 CALIFORNIA ELECTRICAL CODE 2022 CALIFORNIA FIRE CODE 2022 CALIFORNIA GREEN BUILDING STANDARDS REGULATION OF THE STATE AND LOCAL FIRE

MARSHALS & CITY ORDINANCE

1 (N) 2ND-FLOOR RESIDENCE

2 (N) GATE

4 (N) WATER METER

6 (N) RETAINING WALL

9 (N)Water Supply Tank

11 (E)Public Water Line

13 (N)Fence

10 (E)Public Sanitary Sewer Line

7 (N) SEWER LINE

8 (N)Water Pump

5 DRIVEWAY

CITY OF MARTINEZ MUNICIPAL CODE

ENGINEER.LEI@GMAIL.COM

SYMBOL LEGEND

DRAINAGE DIRECTION AND SLOPE PROPERTY LINE CORNER POINTS AND **ELEVATION DATUM**

KEYNOTE CALLOUTS EXISTING TO BE REMAINED AND NEW CONSTRUCTION EXISTING TO BE DEMOLISHED

DEFERRED SUBMITTALS


PV SYSTEM WILL BE UNDER A SEPARATE PERMIT FIRE SPRINKLER SYSTEM PLAN


(E) TREE

PARCEL MAP

SCALE: 1" = 80'-0"

SITE PLAN 1" = 80'-0" (**1**

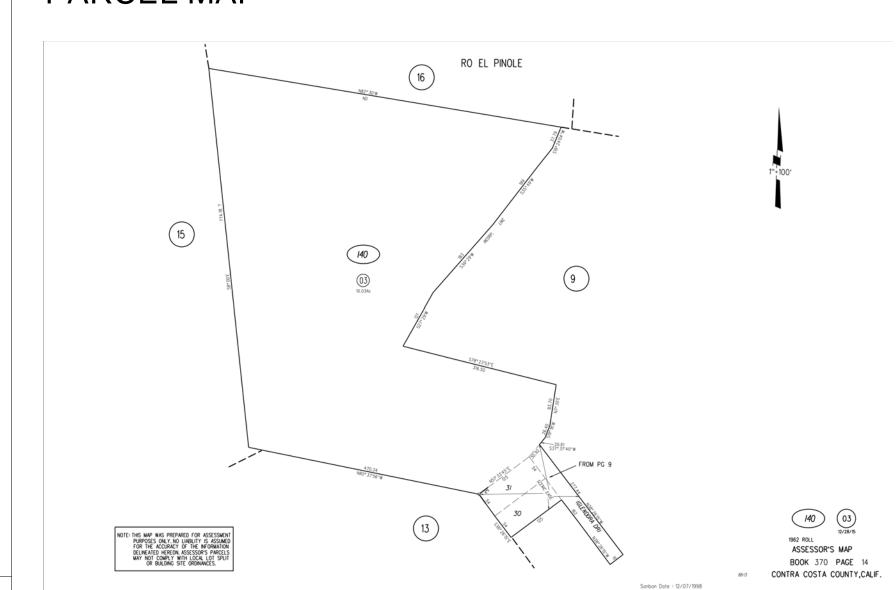

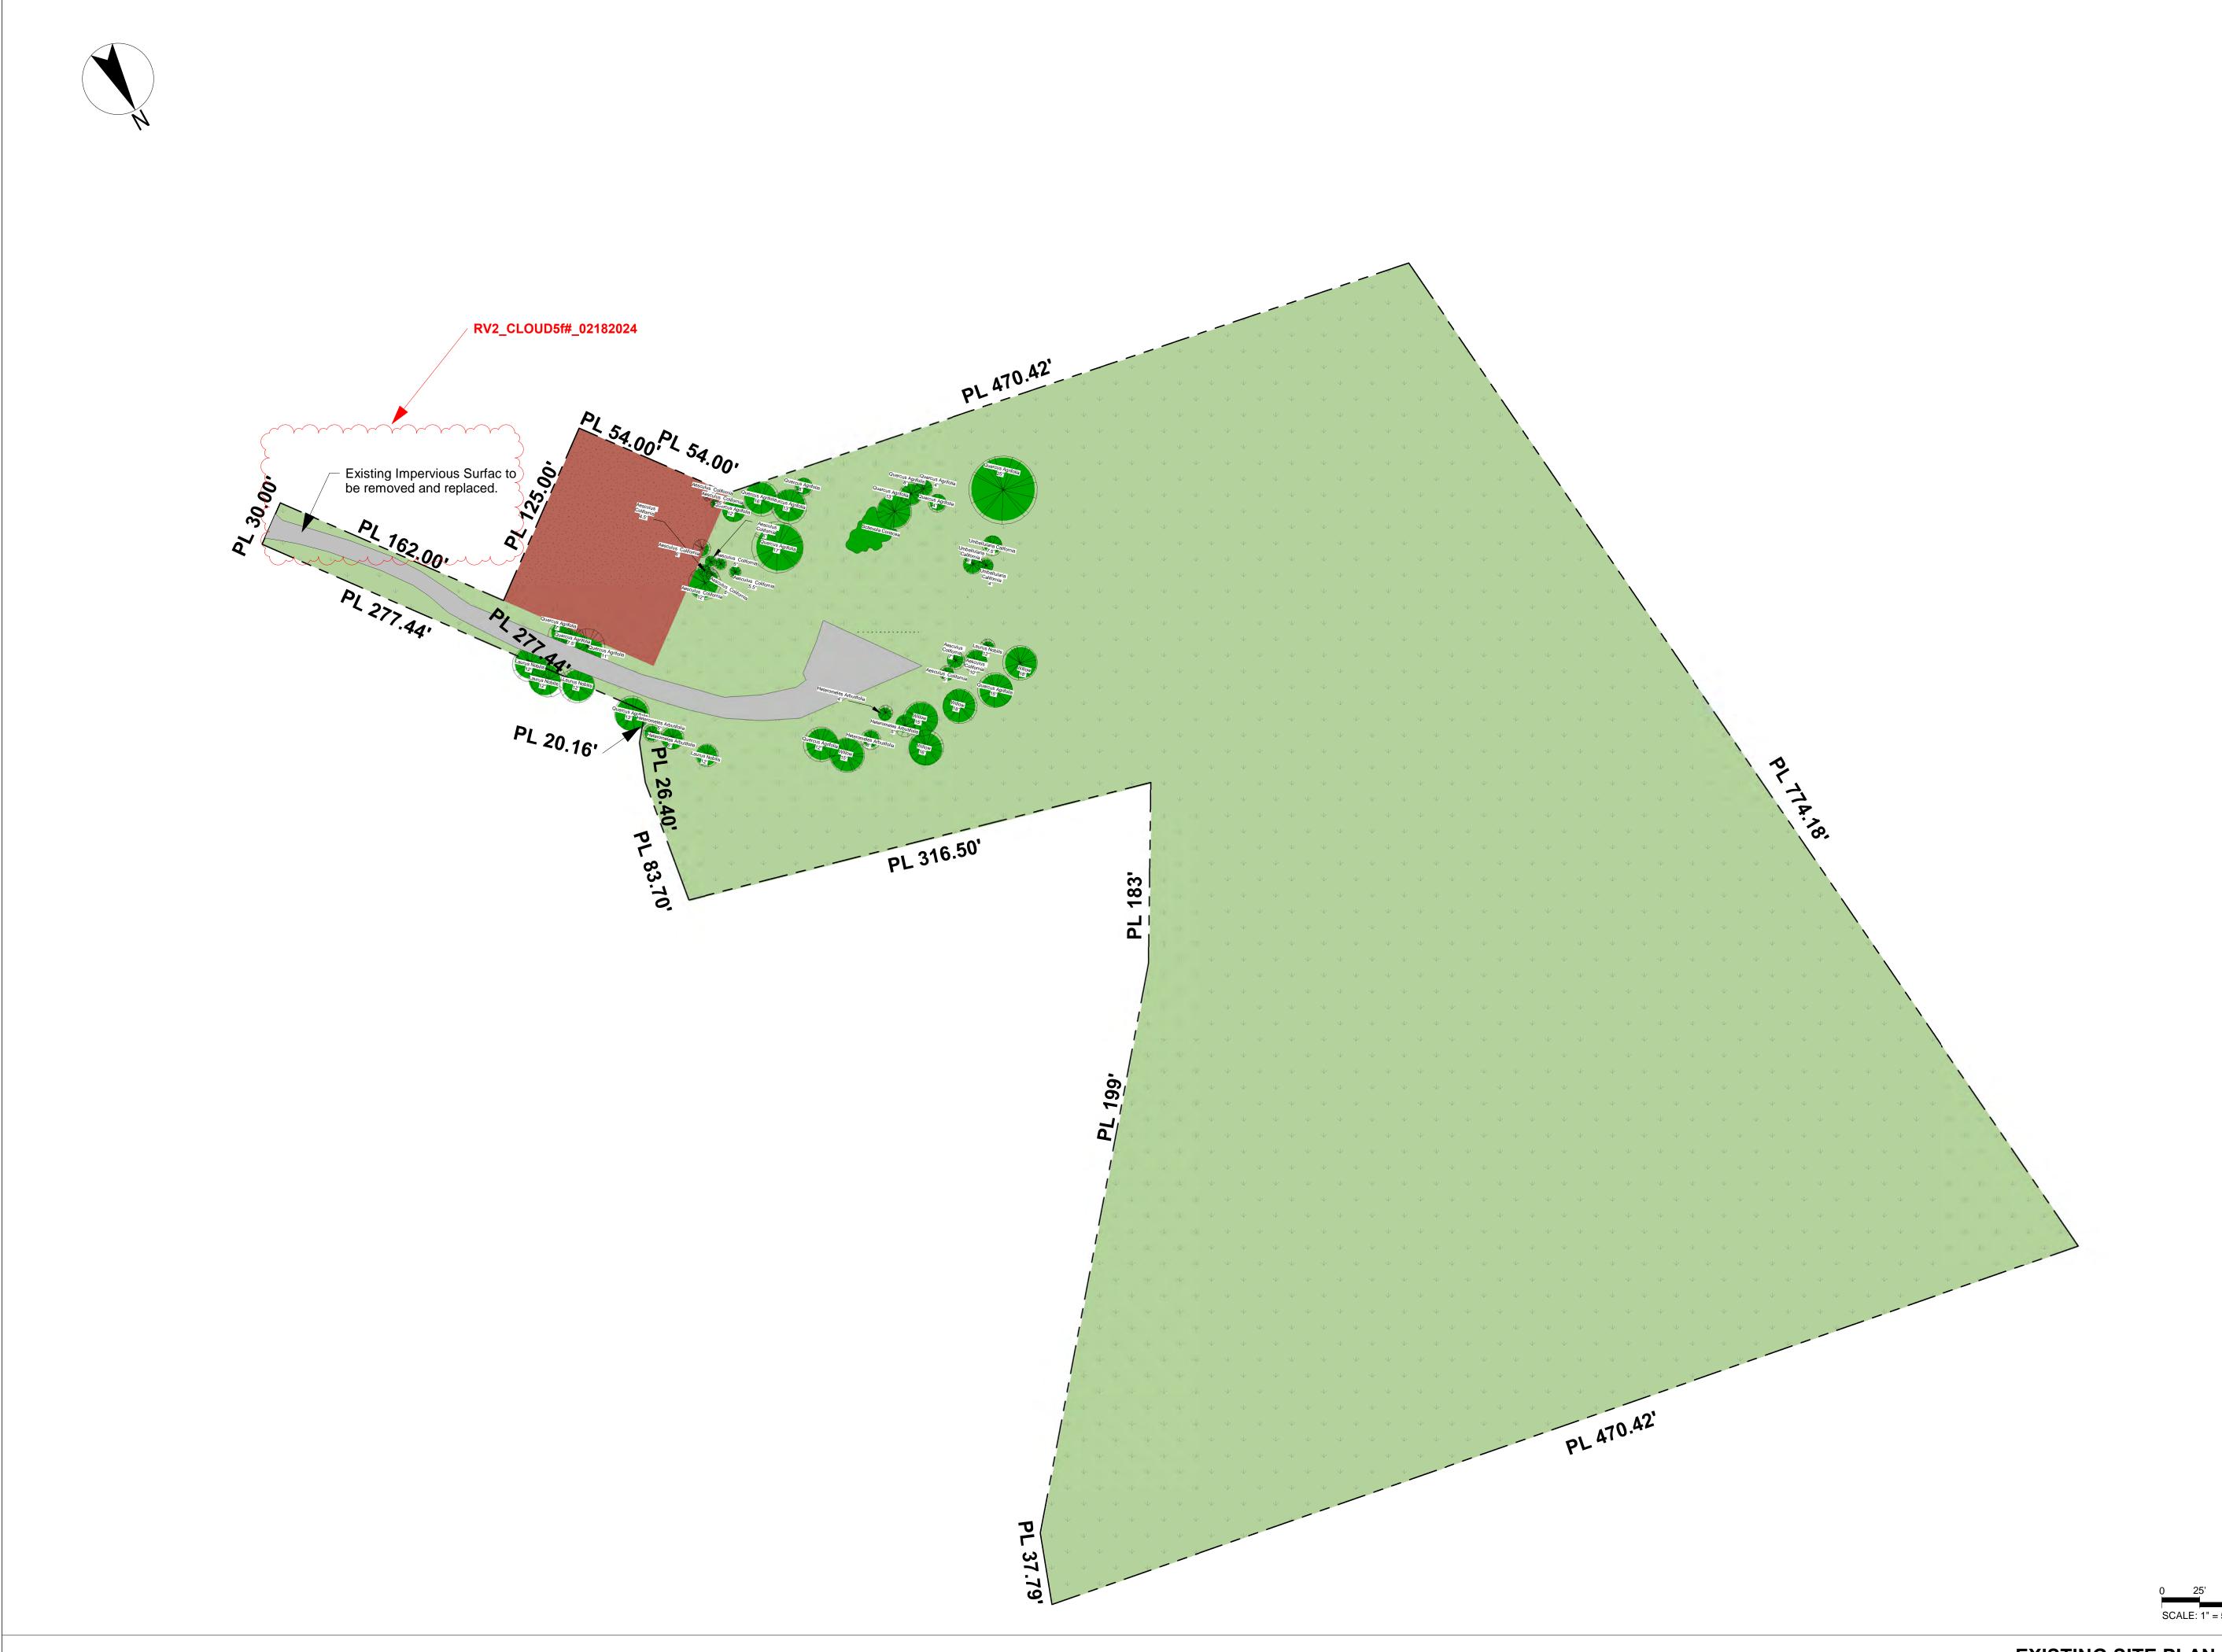



0 40

1			
	REV.	DESCRIPTION	DATE
	0	APPLY FOR PERMITS	07/03/23
	1	1ST PLAN CHECK	09/27/2023
	2	2ND PLAN CHECK	01/10/2024



SHEET TITLE:

EXISTING SITE PLAN

SHEET NUMBER:

A0.1


EXISTING SITE PLAN 1" = 50'-0" 1






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140 GLENDORA DR, MARTINEZ, CA 94553

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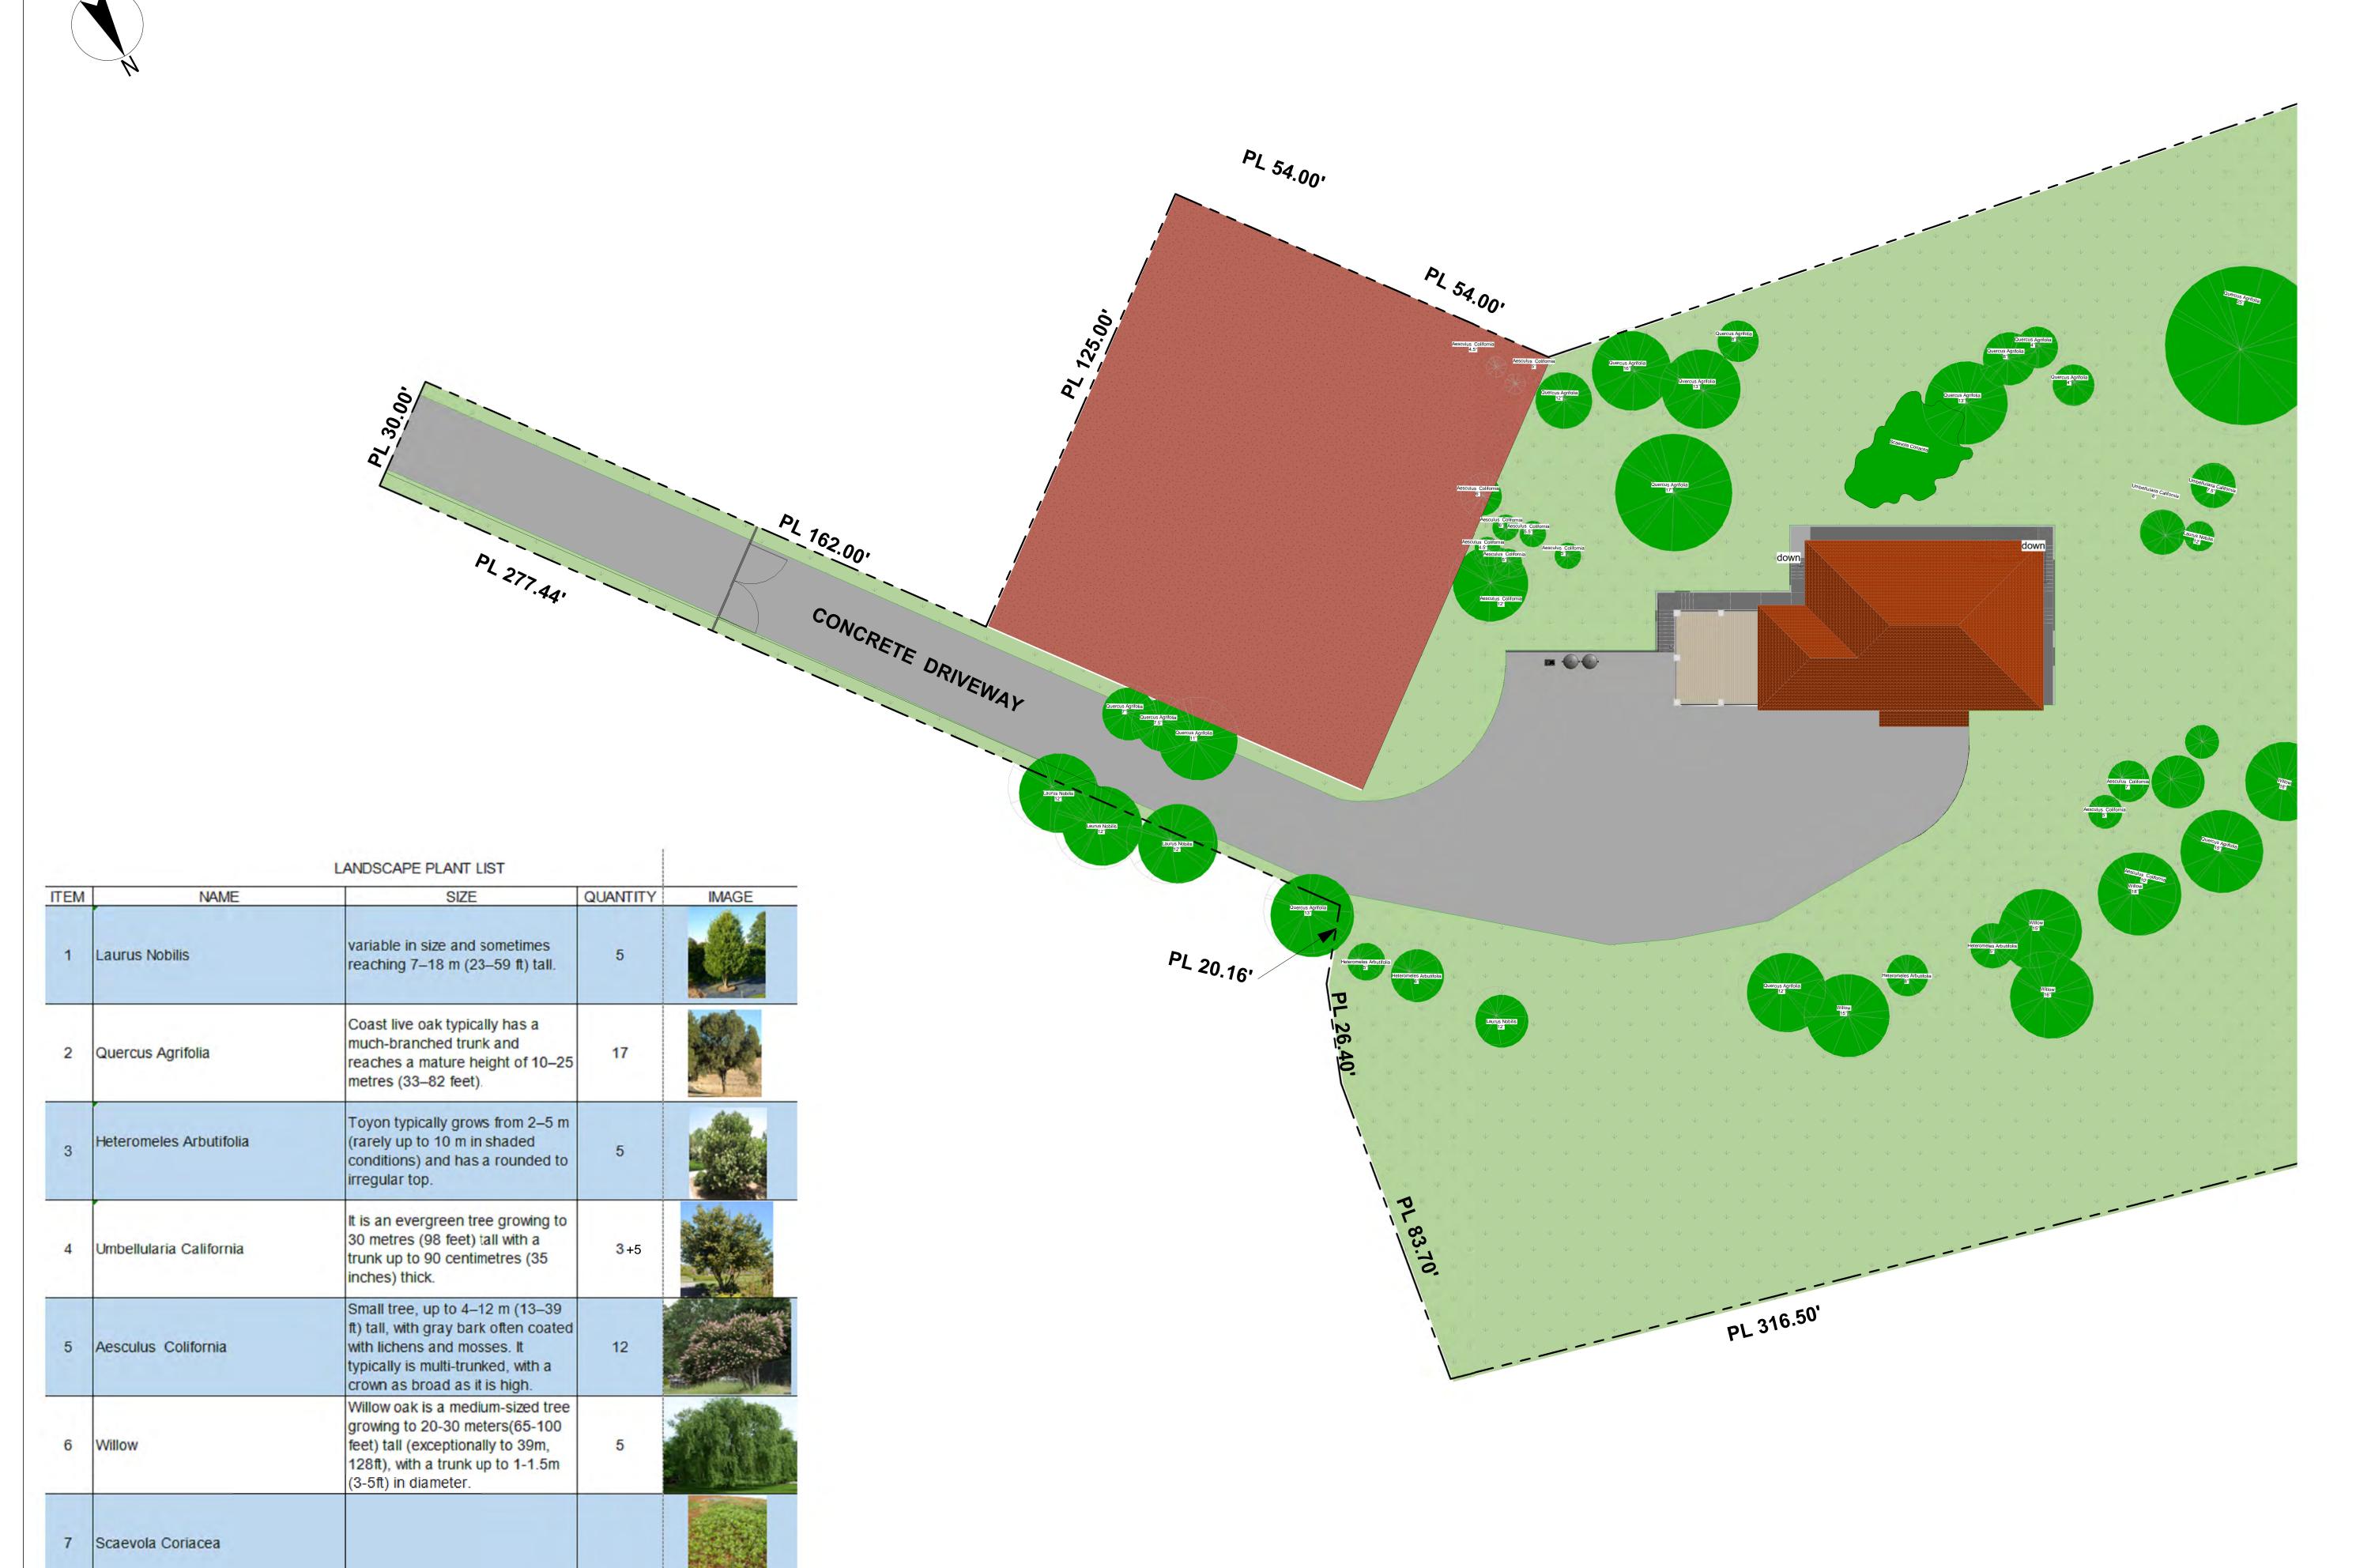
SHEET TITLE:

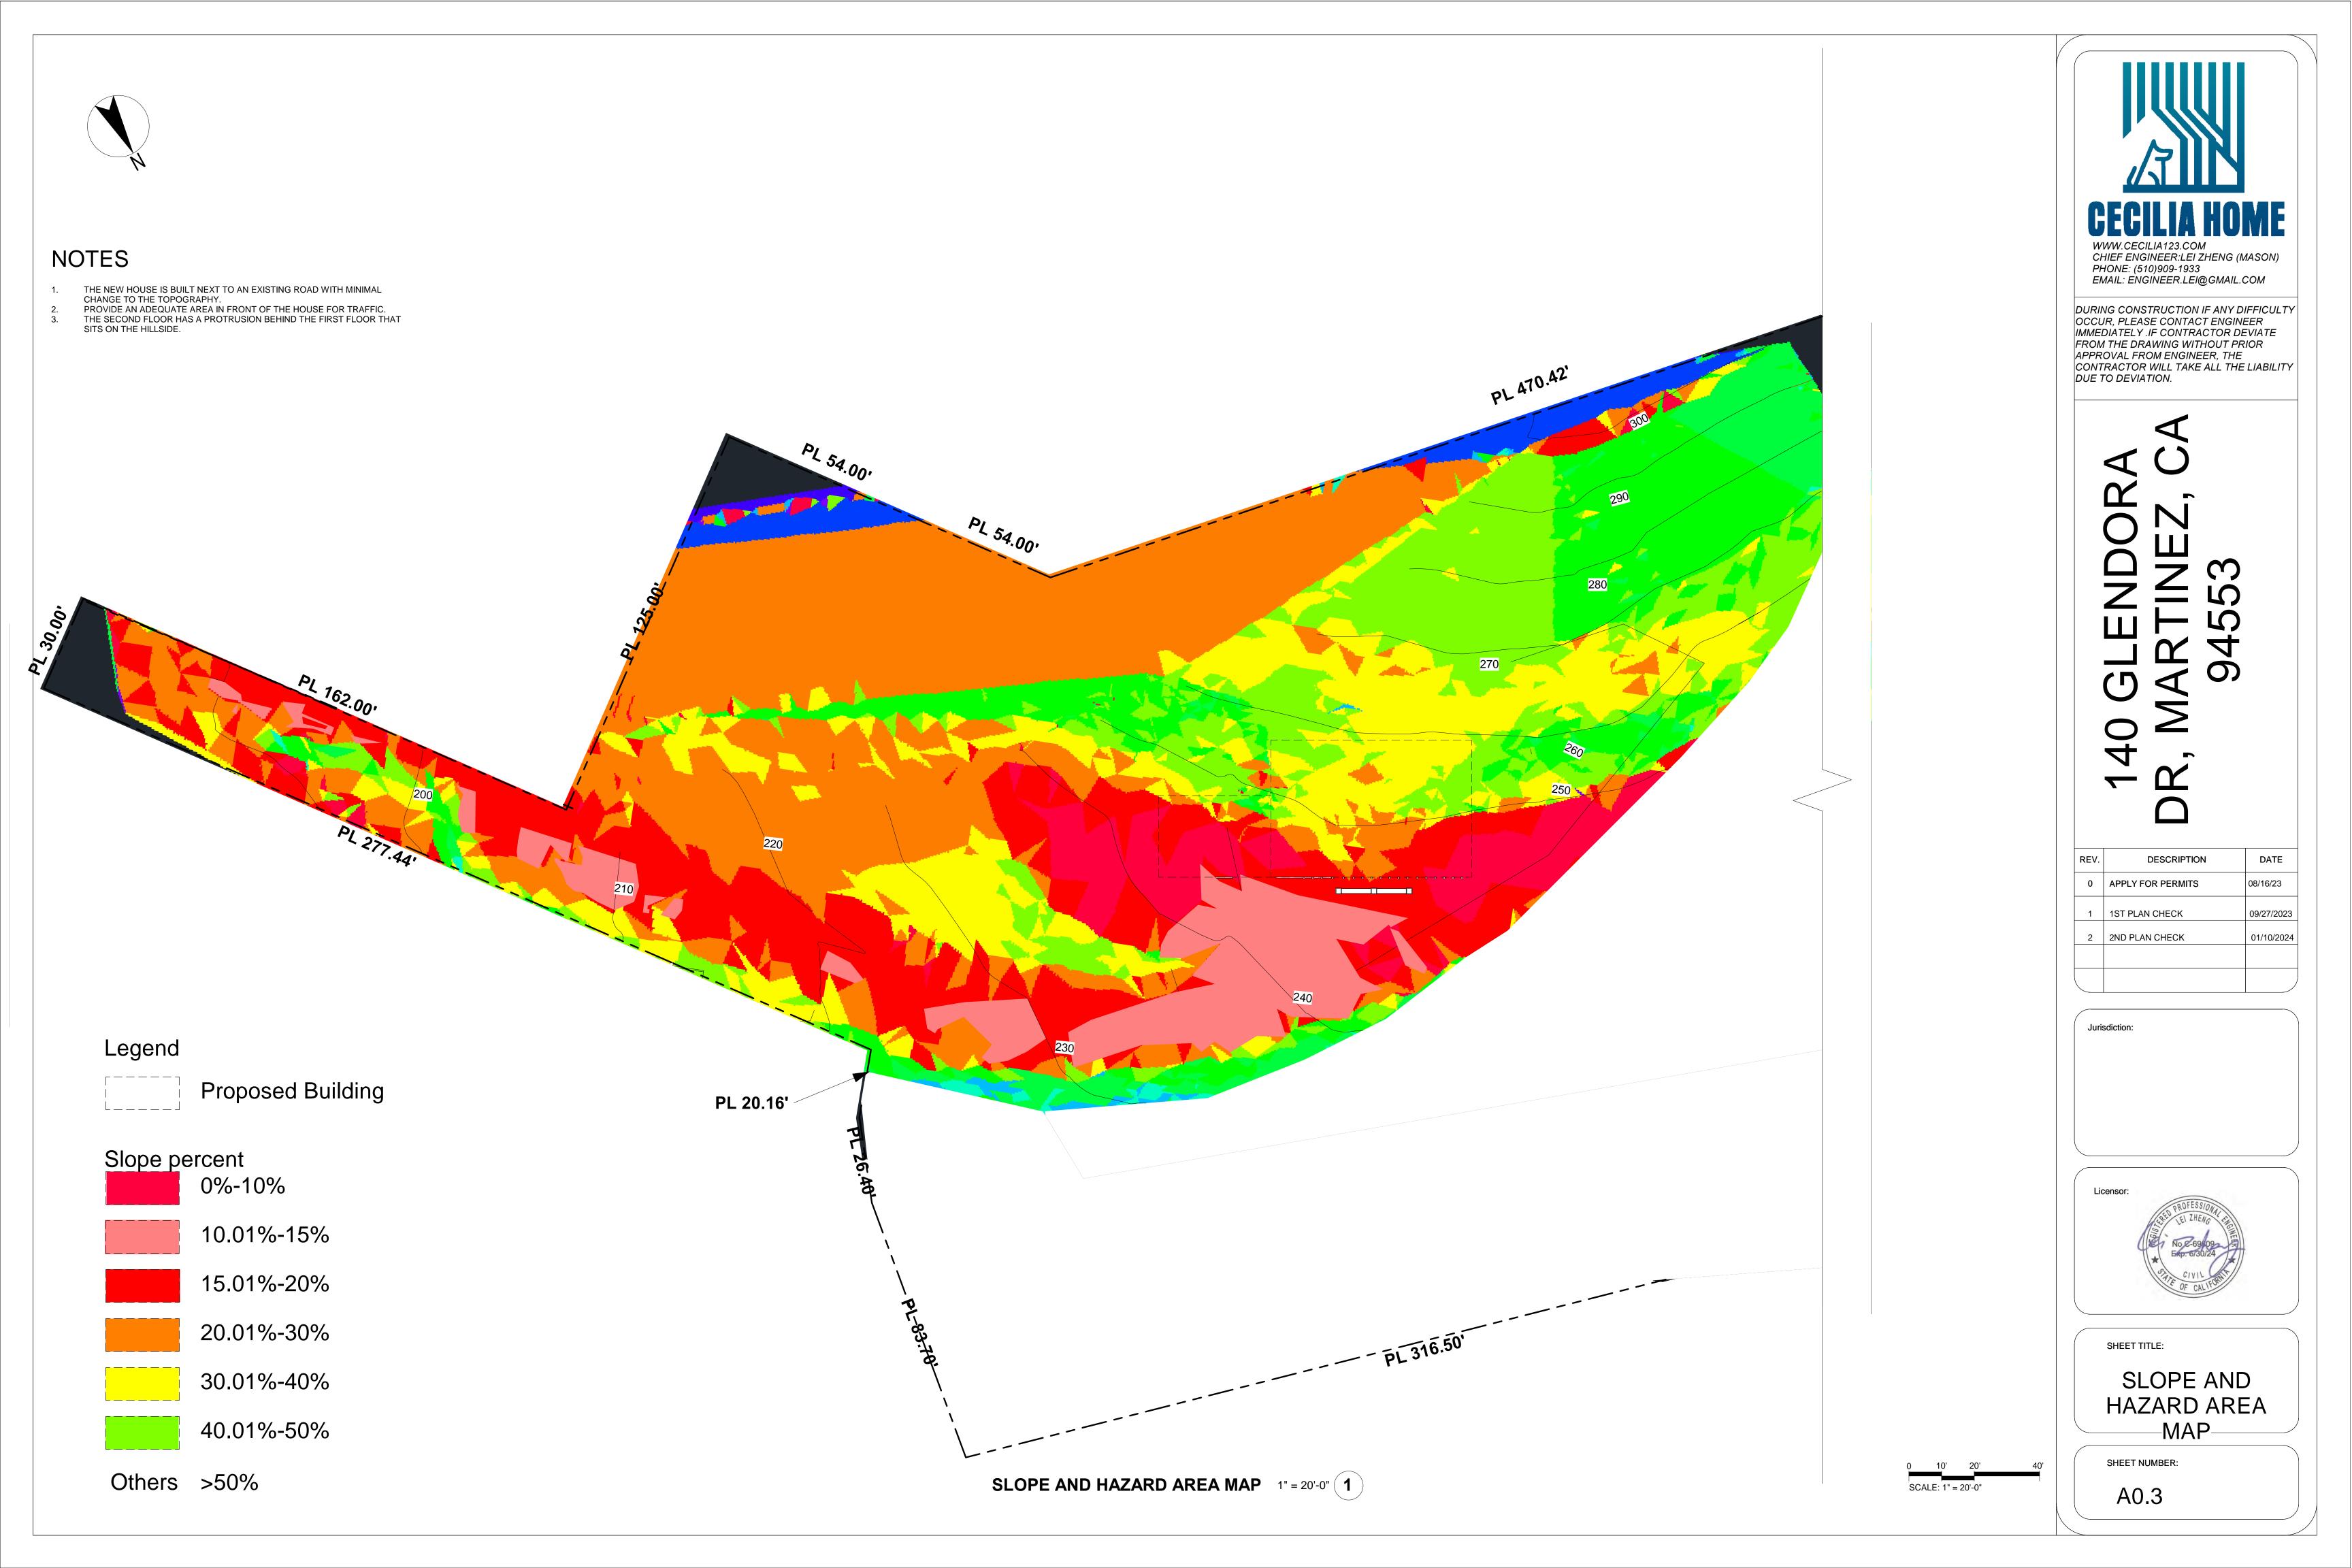PARTIAL SITE PLAN

SHEET NUMBER:

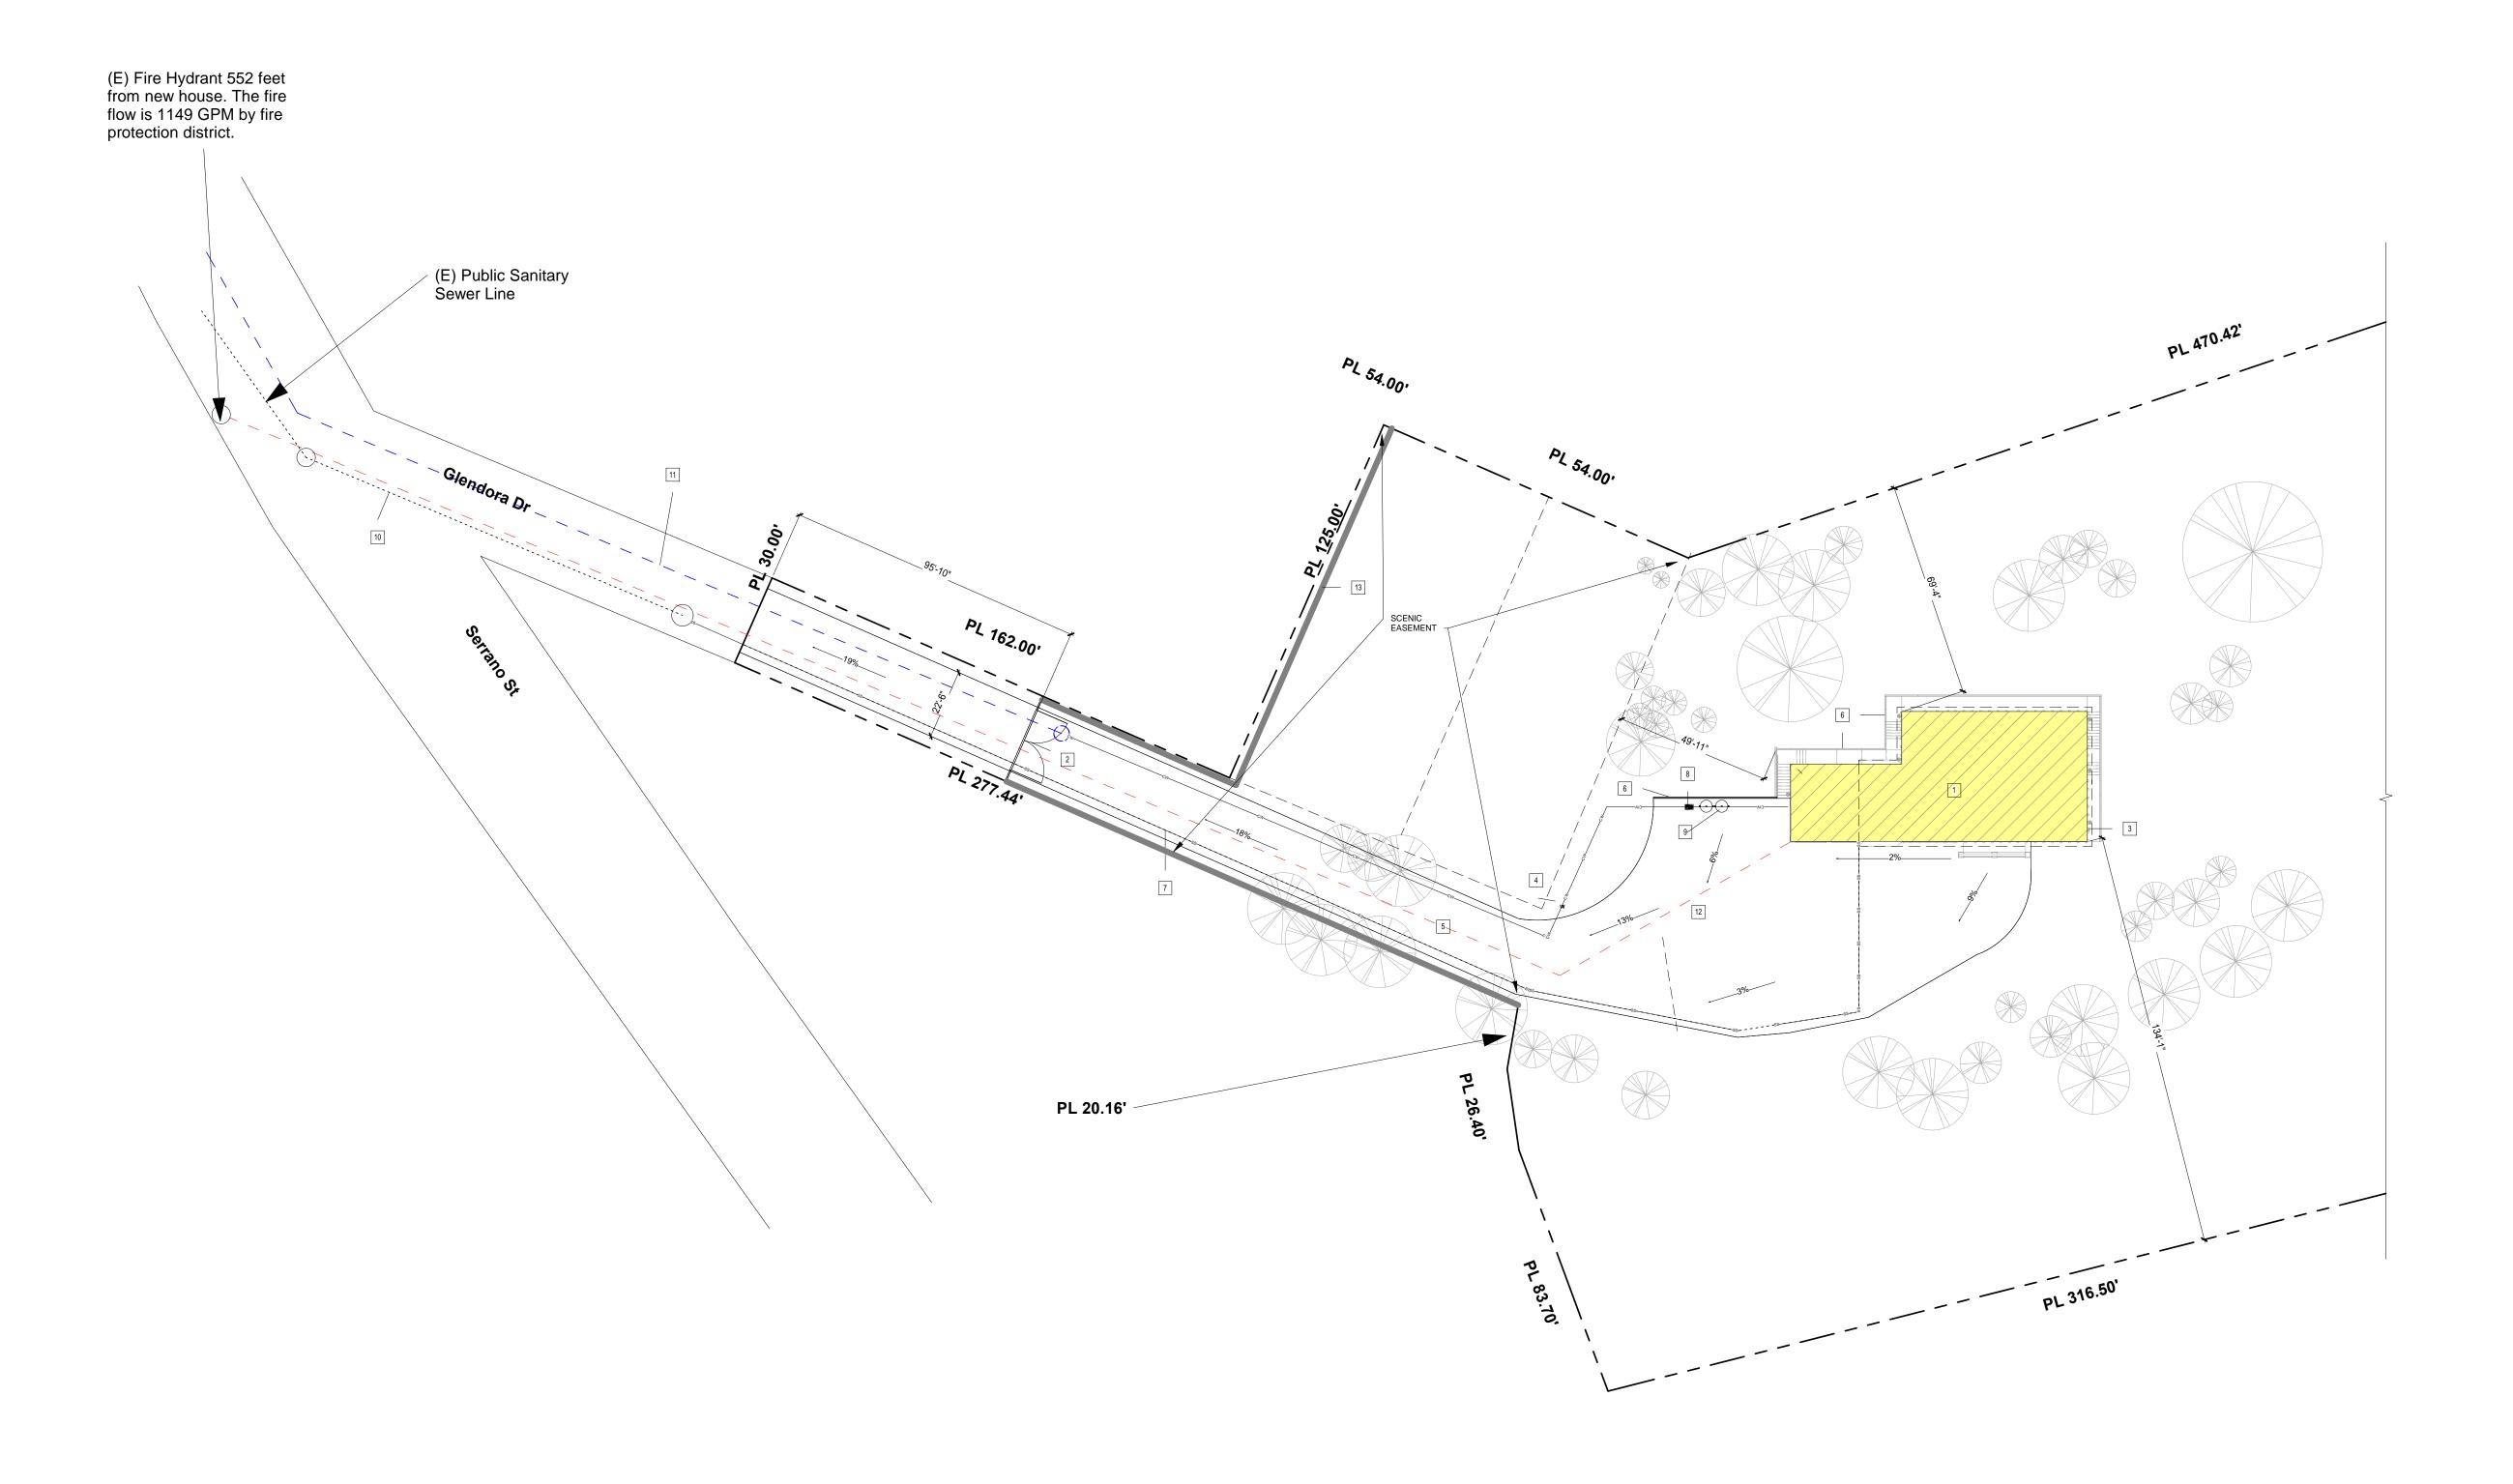A1

PARTIAL SITE PLAN 1" = 30'-0" (1)





40

- 1			
	REV.	DESCRIPTION	DATE
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	2	2ND PLAN CHECK	01/10/2024

Jurisdiction:

Licensor:


SHEET TITLE:

PARTIAL LANDSCAPE

SHEET NUMBER: A1.1

LANDSCAPE 1" = 20'-0" (1)

SCALE: 1" = 20'-0"

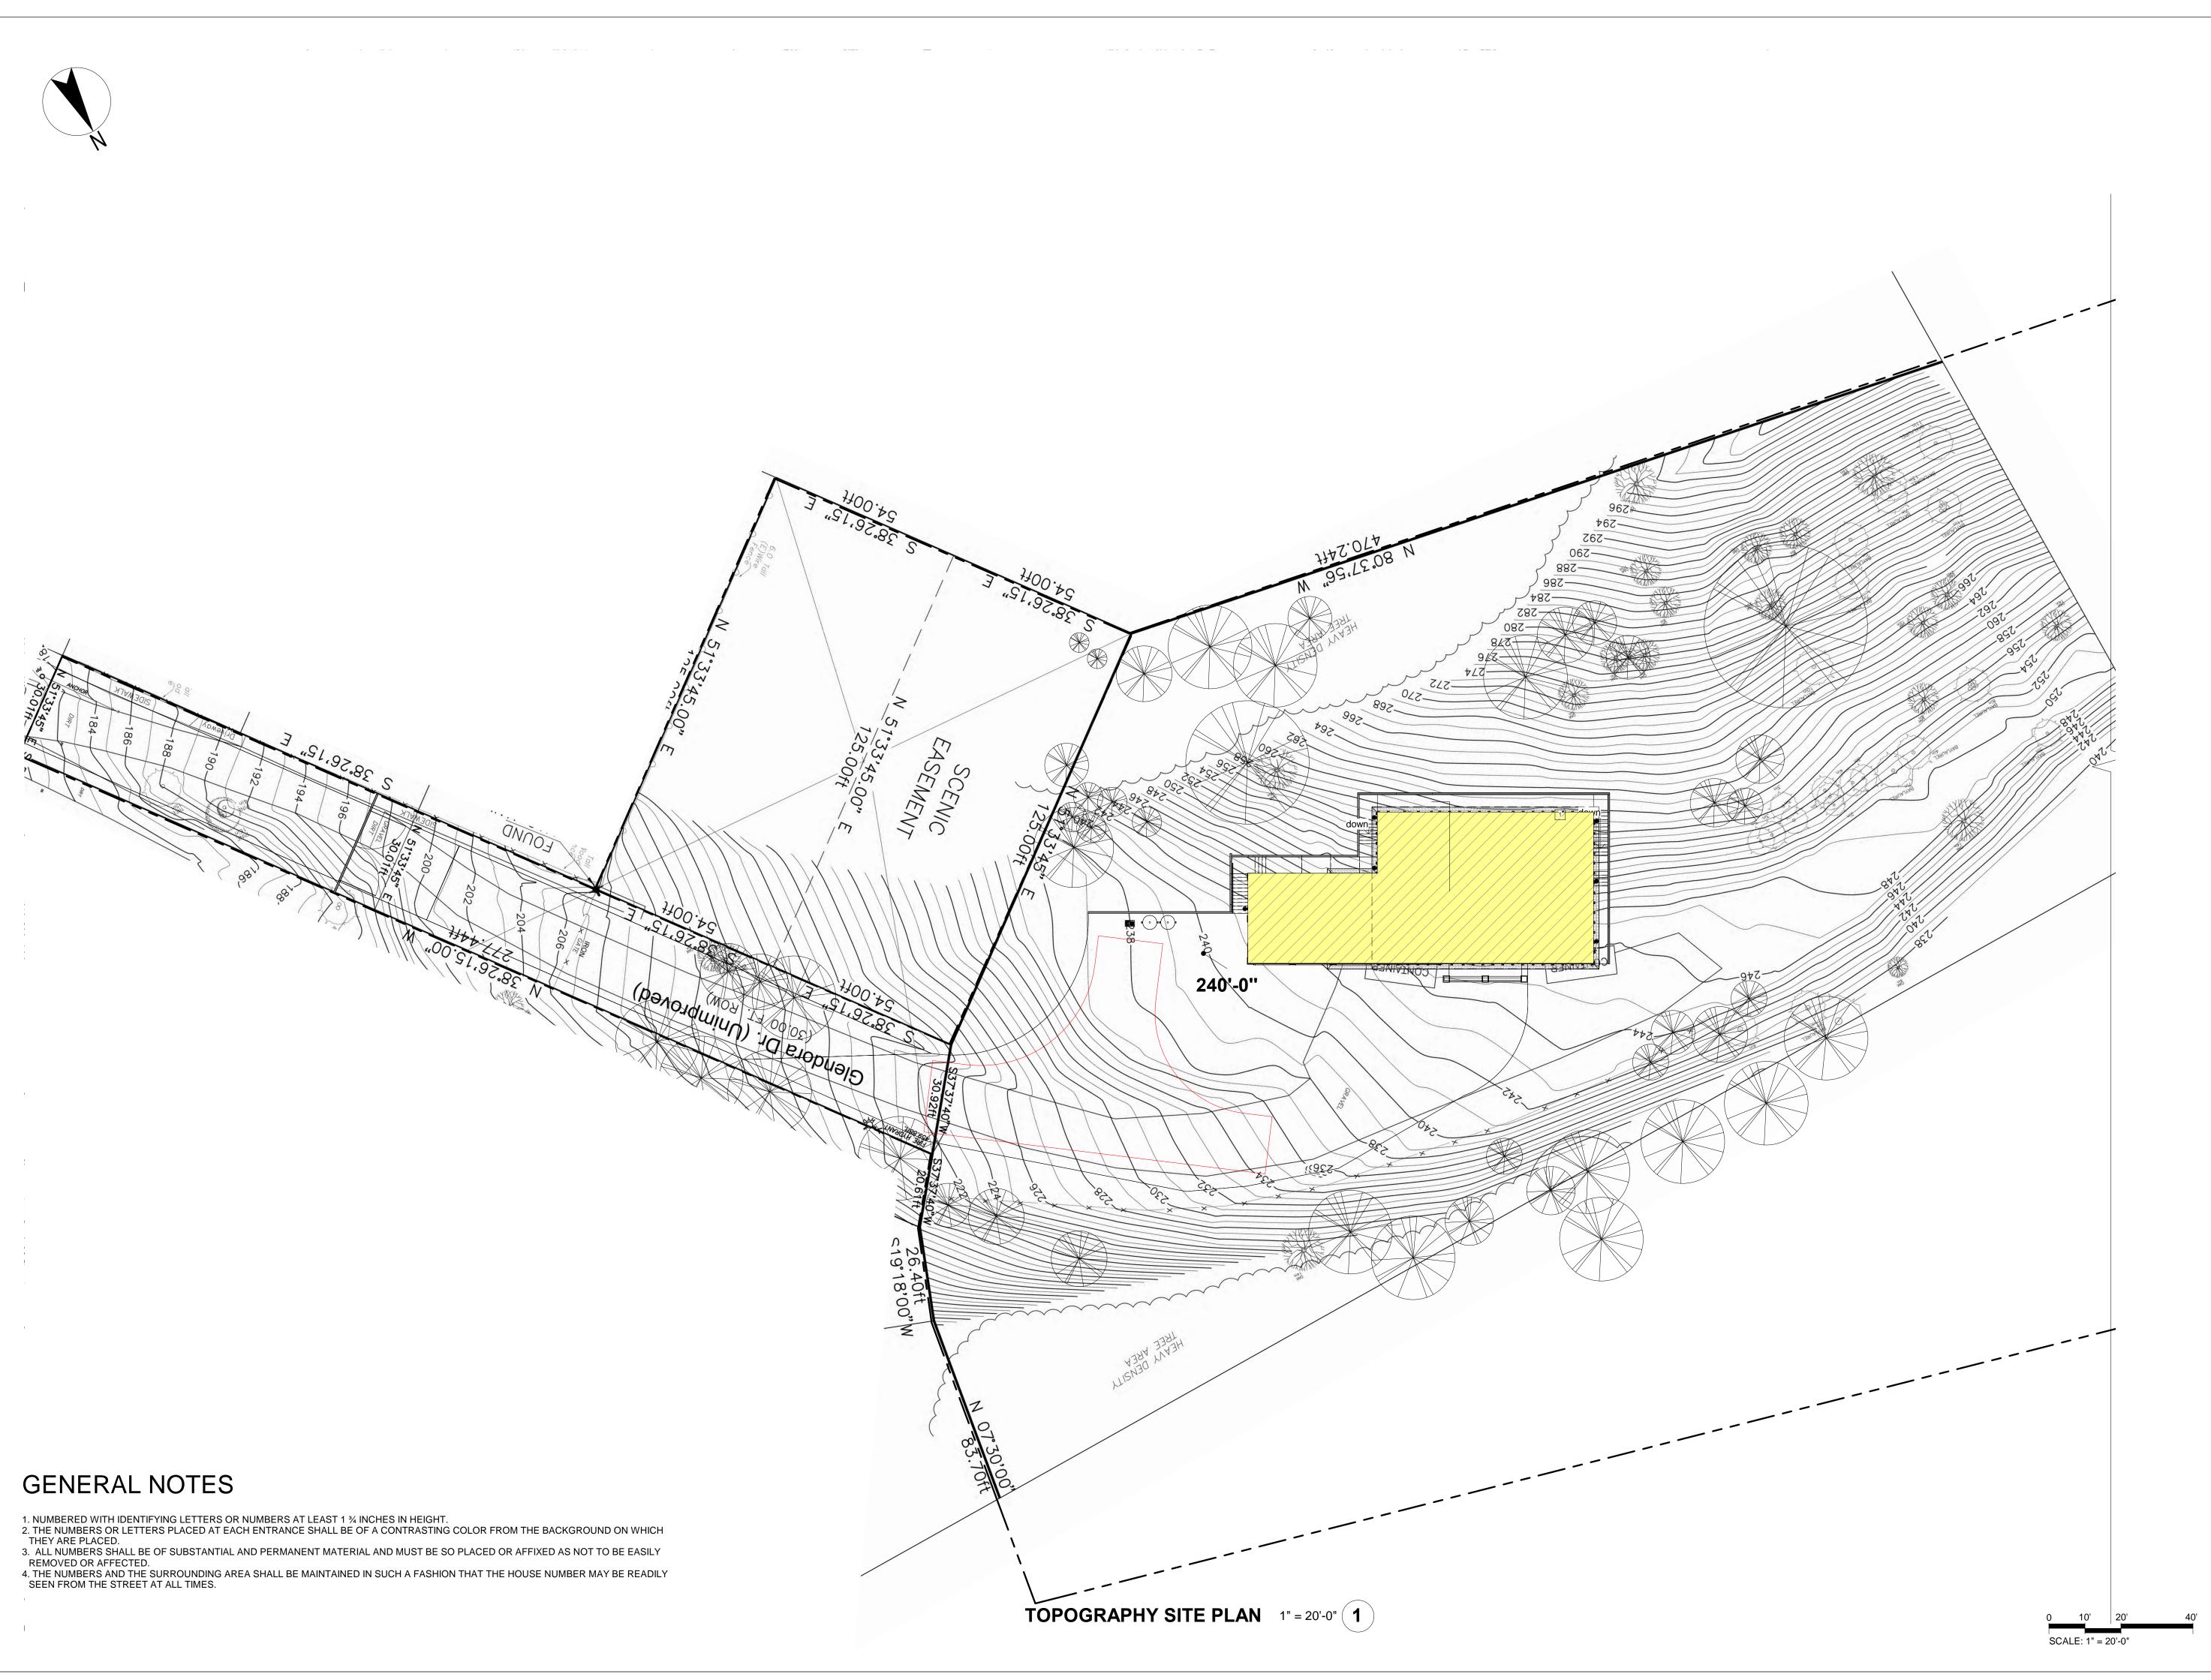




WWW.CECILIA123.COM CHIEF ENGINEER:LEI ZHENG (MASON) PHONE: (510)909-1933 EMAIL: ENGINEER.LEI@GMAIL.COM

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140 GLENDORA DR, MARTINEZ, CA 94553

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Jurisdiction:



SHEET TITLE:

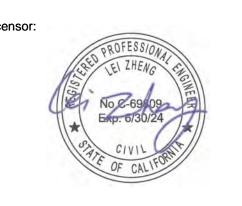TOPOGRAPHY SITE PLAN

SHEET NUMBER:

A1.2



RV2_CLOUD2f#_02182024


FIRE PROTECTION NOTES

24 1. GRADES EXCEEDING 16% SHALL BE CONSTRUCTED OF GROOVED CONCRETE PER THE FIRE DISTRICT STANDARD. (503)CFC

2. ACCESS ROADWAYS OF LESS THAN 28-FEET UNOBSTRUCTED WIDTH SHALL HAVE SIGNS POSTED OR CURBS PAINTED RED WITH THE WORDS: NO PARKING-FIRE LANE CLEARLY MARKED. ACCESS ROADWAYS OF 28 FEET OR GREATER, BUT LESS THAN 36-FEET UNOBSTRUCTED WIDTH SHALL HAVE NO PARKING-FIRE LANE SIGNS POSTED, ALLOWING FOR PARKING ON ONE SIDE ONLY OR CURBS PAINTED RED WITH THE WORDS NO PARKING-FIRE LANE CLEARLY MARKED. (22500.1)CVC, (503.3) CFC

- 3. THE DEVELOPER SHALL PROVIDE AN ADEQUATE AND RELIABLE WATER SUPPLY FOR FIRE PROTECTION WITH A MINIMUM FIRE FLOW OF 875 GPM. REQUIRED FLOW MUST BE DELIVERED FROM NOT MORE THAN 1 HYDRANT FLOWING FOR A DURATION OF 120 MINUTES WHILE MAINTAINING 20-POUNDS RESIDUAL PRESSURE IN THE MAIN. (507.1), (B105) CFC
- 4. THE DEVELOPER SHALL PROVIDE AN ADEQUATE AND RELIABLE WATER SUPPLY FOR FIRE PROTECTION AS SET FORTH IN THE CALIFORNIA FIRE CODE. (507.1) CFC.
- 5. EMERGENCY APPARATUS ACCESS ROADWAYS AND HYDRANTS SHALL BE INSTALLED, IN SERVICE, AND INSPECTED BY THE FIRE DISTRICT PRIOR TO CONSTRUCTION OR COMBUSTIBLE STORAGE ON SITE. (501.4) CFC
- 6. A TEMPORARY AGGREGATE BASE OR ASPHALT GRINDINGS ROADWAY IS NOT CONSIDERED AN ALL-WEATHER SURFACE FOR EMERGENCY APPARATUS ACCESS. THE FIRST LIFT OF ASPHALT CONCRETE PAVING SHALL BE INSTALLED AS THE MINIMUM ROADWAY MATERIAL AND MUST BE ENGINEERED TO SUPPORT THE DESIGNATED GROSS VEHICLE WEIGHT OF 37 TONS.
- 7. FLAMMABLE OR COMBUSTIBLE LIGUID STORAGE TANKS SHALL NOT BE LOCATED ON THE SITE WITHOUT OBTAINING APPROVAL AND NECESSARY PERMITS FROM THE FIRE DISTRICT. (3401.4) CFC
- 8. THE OWNER SHALL CUT DOWN AND REMOVE ALL WEEDS, GRASS, VINES, OR OTHER GROWTH THAT IS CAPABLE OF BEING IGNITED AND ENDANGERING PROPERTY. (304.1.2) CFC
- 9. PLANS SHALL BE SUBMITTED TO THE FIRE DISTRICT FOR REVIEW AND APPROVAL PRIOR TO CONSTRUCTION OF THE BUILDING OR INSTALLATION OF THE SYSTEMS TO ENSURE COMPLIANCE WITH MINIMUM REQUIREMENTS RELATED TO FIRE AND LIFE SAFETY. PLAN REVIEW AND INSPECTION FEES SHALL BE SUBMITTED AT THE TIMEL OF PLAN REVIEW SUBMITTAL. (105.4.1) CFC, (901.2) CFC, (107) CBC
- 10. CONTACT THE FIRE DISTRICT (MINIMUM 2 WORKING DAYS IN ADVANCE) AT 925-9413300 EXT 3902 TO SCHEDULE AN INSPECTION OF THE ACCESS AND HYDRANT INSTALLATION PRIOR TO CONSTRUCTION OR THE STORAGE OF COMBUSTIBLE MATERIALS ON THE JOB SITE.
- 11. STRIPING AND SIGNAGE PLAN TO INCLUDE "NO PARKING-FIRE LANE" MARKINGS.

DISTANCE TO THE CLOSEST EXISTING FIRE HYDEANT

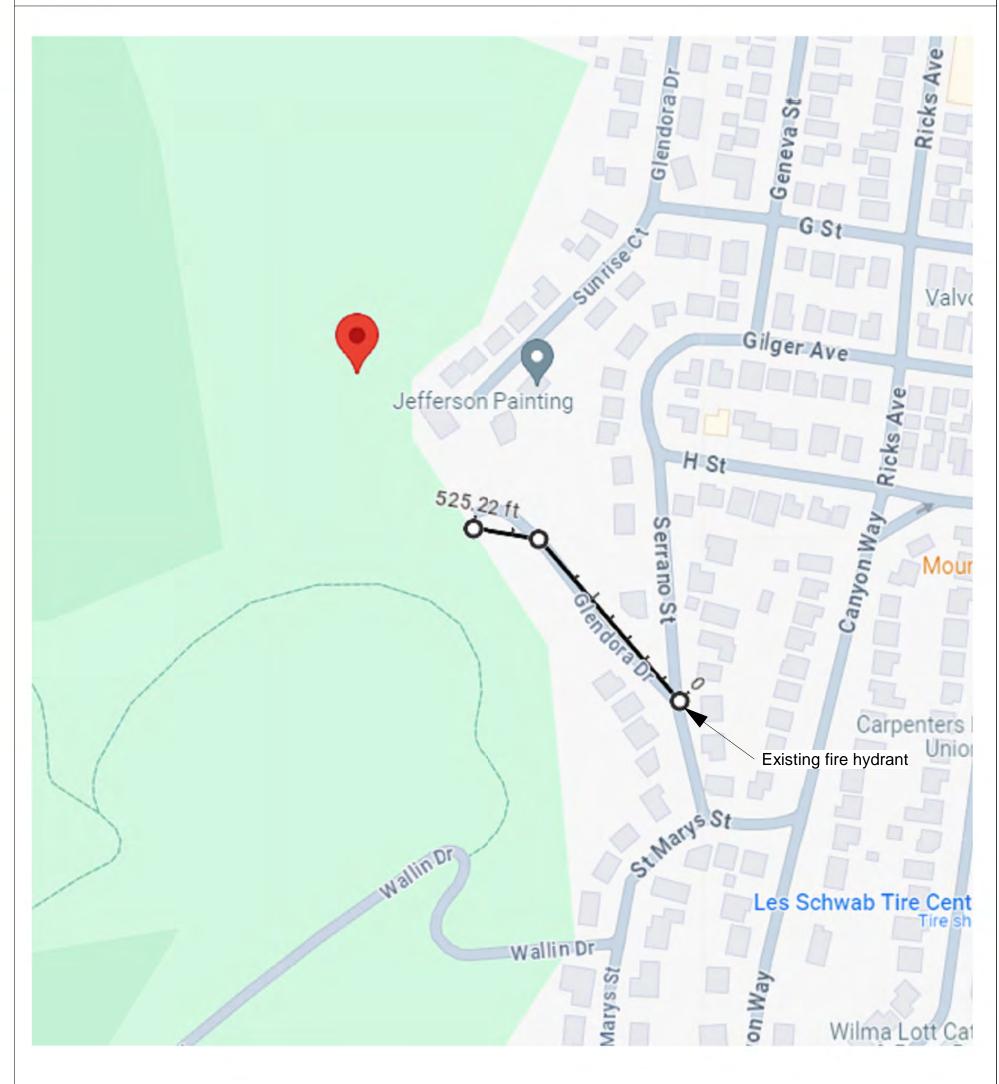

NOTE: THE DISTANCE TO THE CLOSEST EXISTING FIRE HYDRANT IS 525 FEET.



EMAIL: ENGINEER.LEI@GMAIL.COM

DURING CONSTRUCTION IF ANY DIFFICULTY
OCCUR, PLEASE CONTACT ENGINEER
IMMEDIATELY .IF CONTRACTOR DEVIATE
FROM THE DRAWING WITHOUT PRIOR

IMMEDIATELY .IF CONTRACT ENGINEER
IMMEDIATELY .IF CONTRACTOR DEVIATE
FROM THE DRAWING WITHOUT PRIOR
APPROVAL FROM ENGINEER, THE
CONTRACTOR WILL TAKE ALL THE LIABILITY
DUE TO DEVIATION.

140 GLENDORA DR, MARTINEZ, C/ 94553

REV.	DESCRIPTION	DATE
0	APPLY FOR PERMITS	07/03/23
1	1ST PLAN CHECK	09/27/2023
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No e-69109

Exp. 0/30/24

Op. 1 CIVIL


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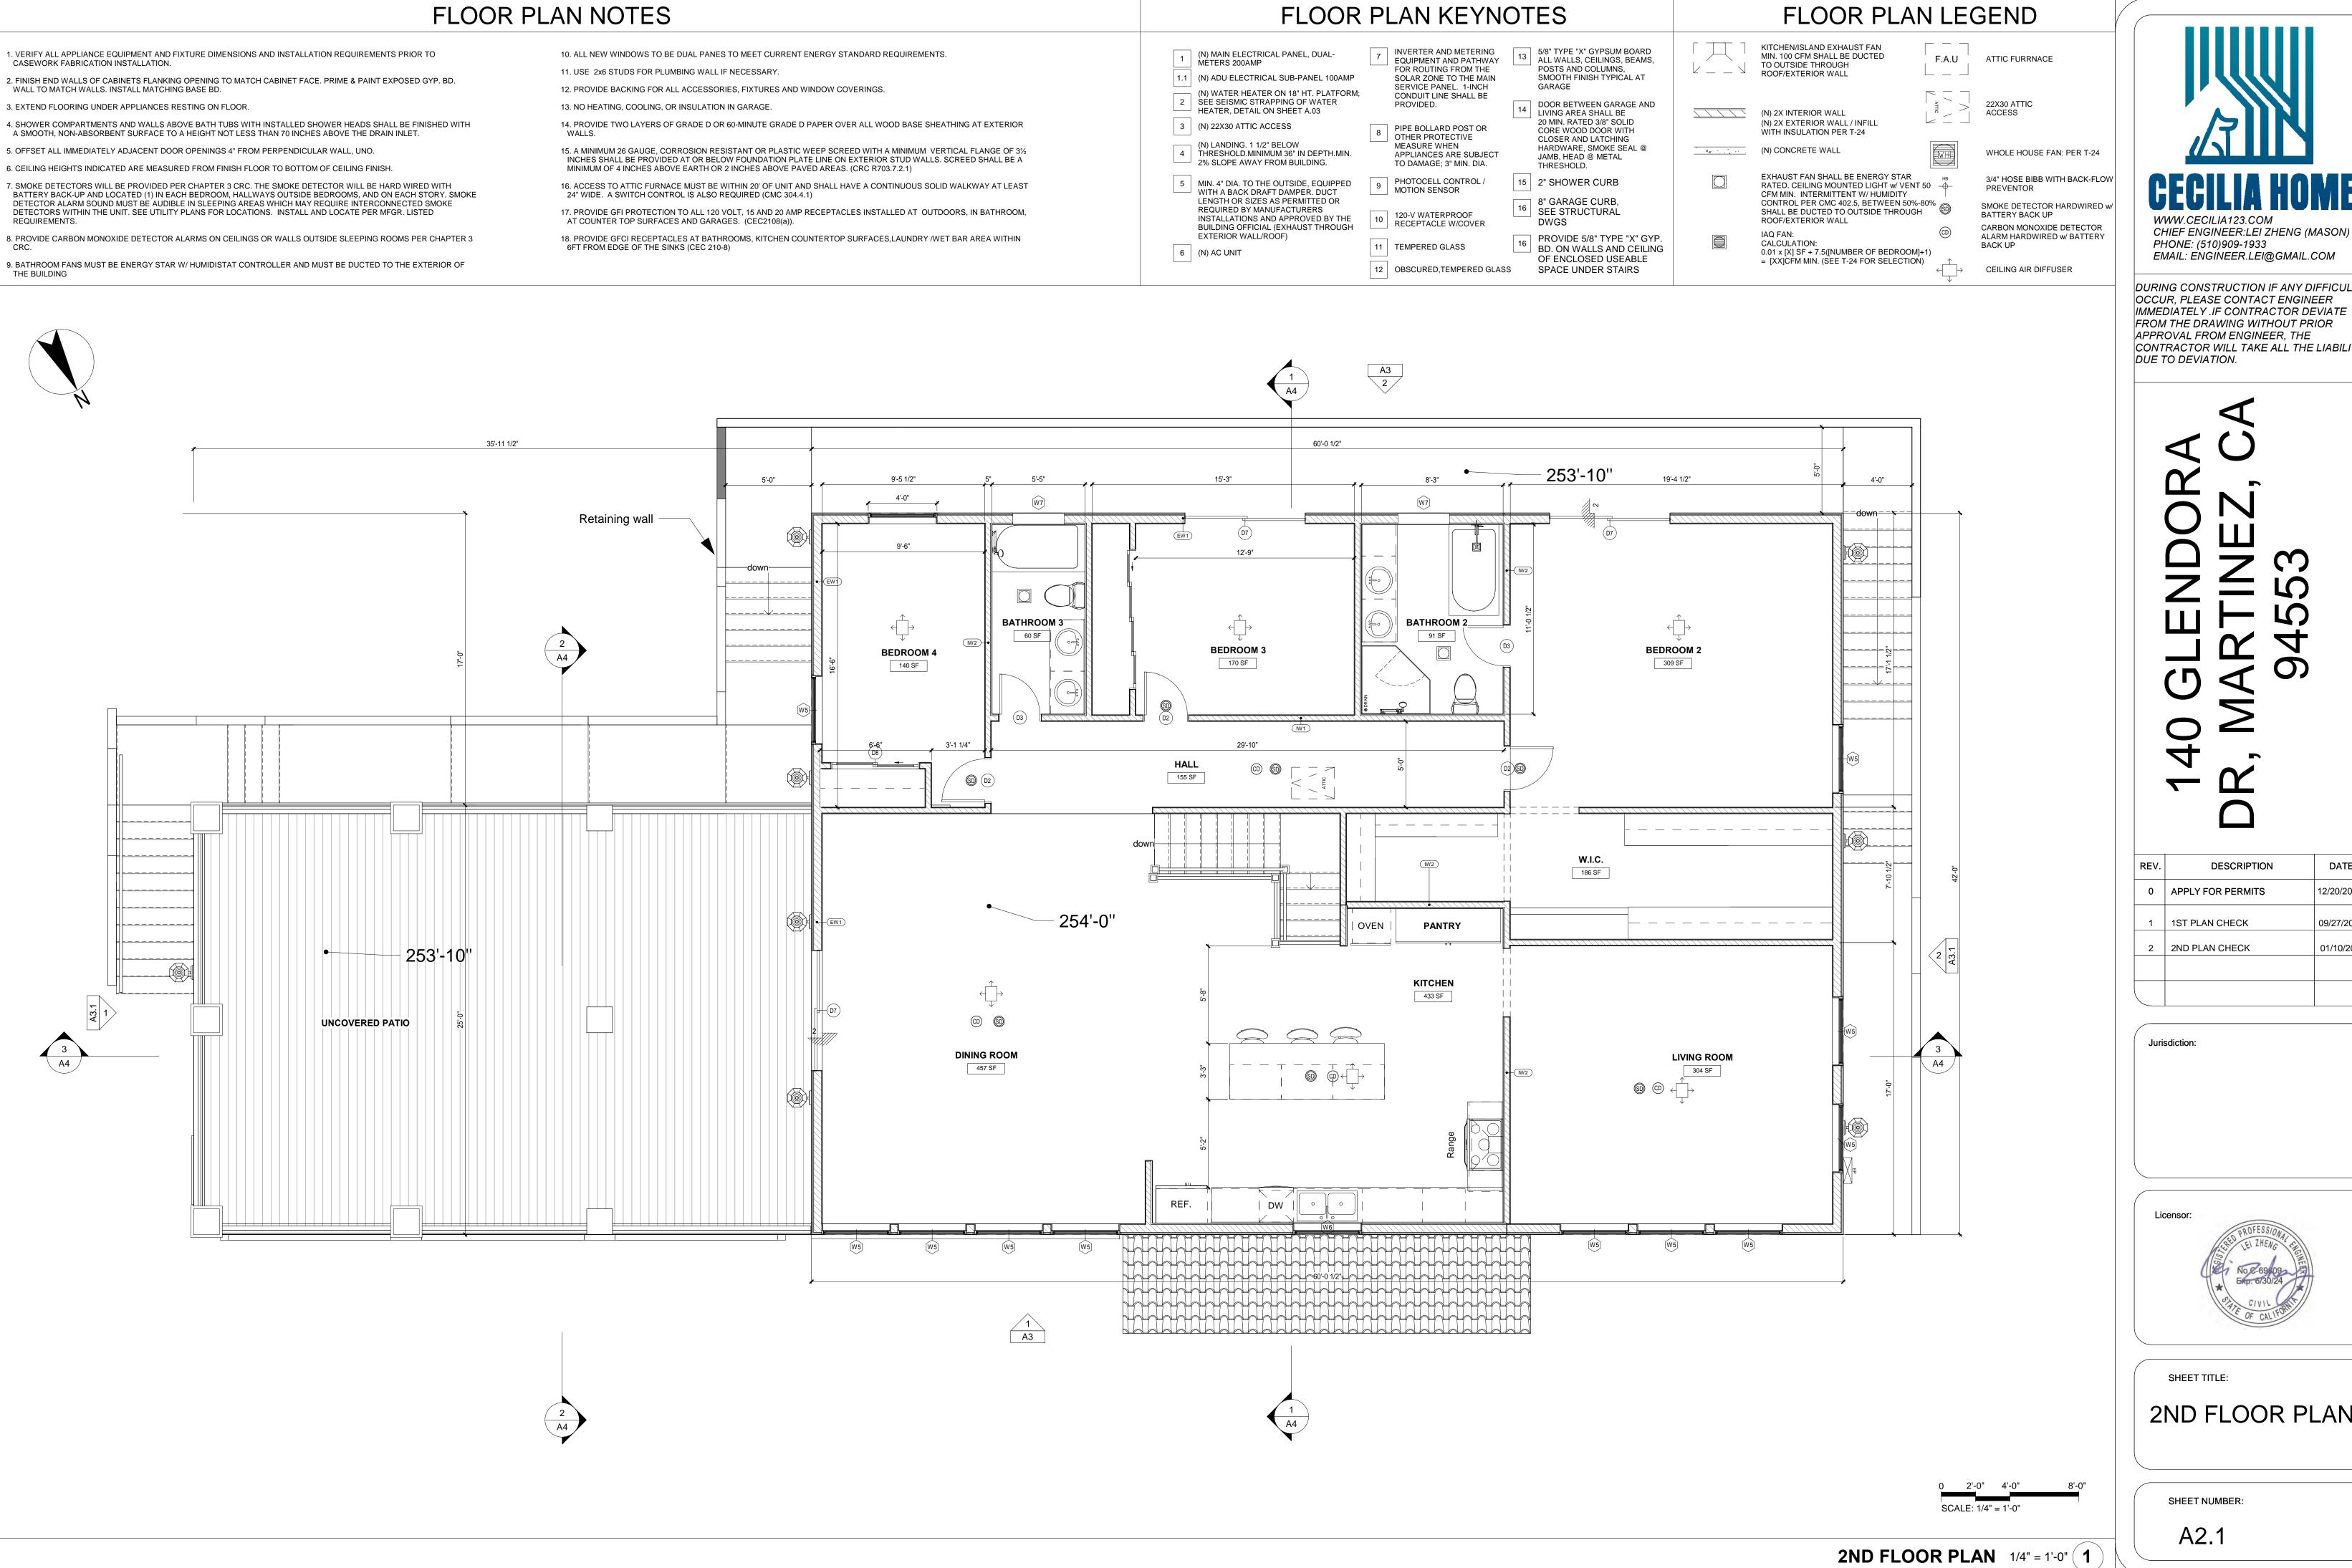
FIRE DESIGN PLAN

SHEET NUMBER

A1.3





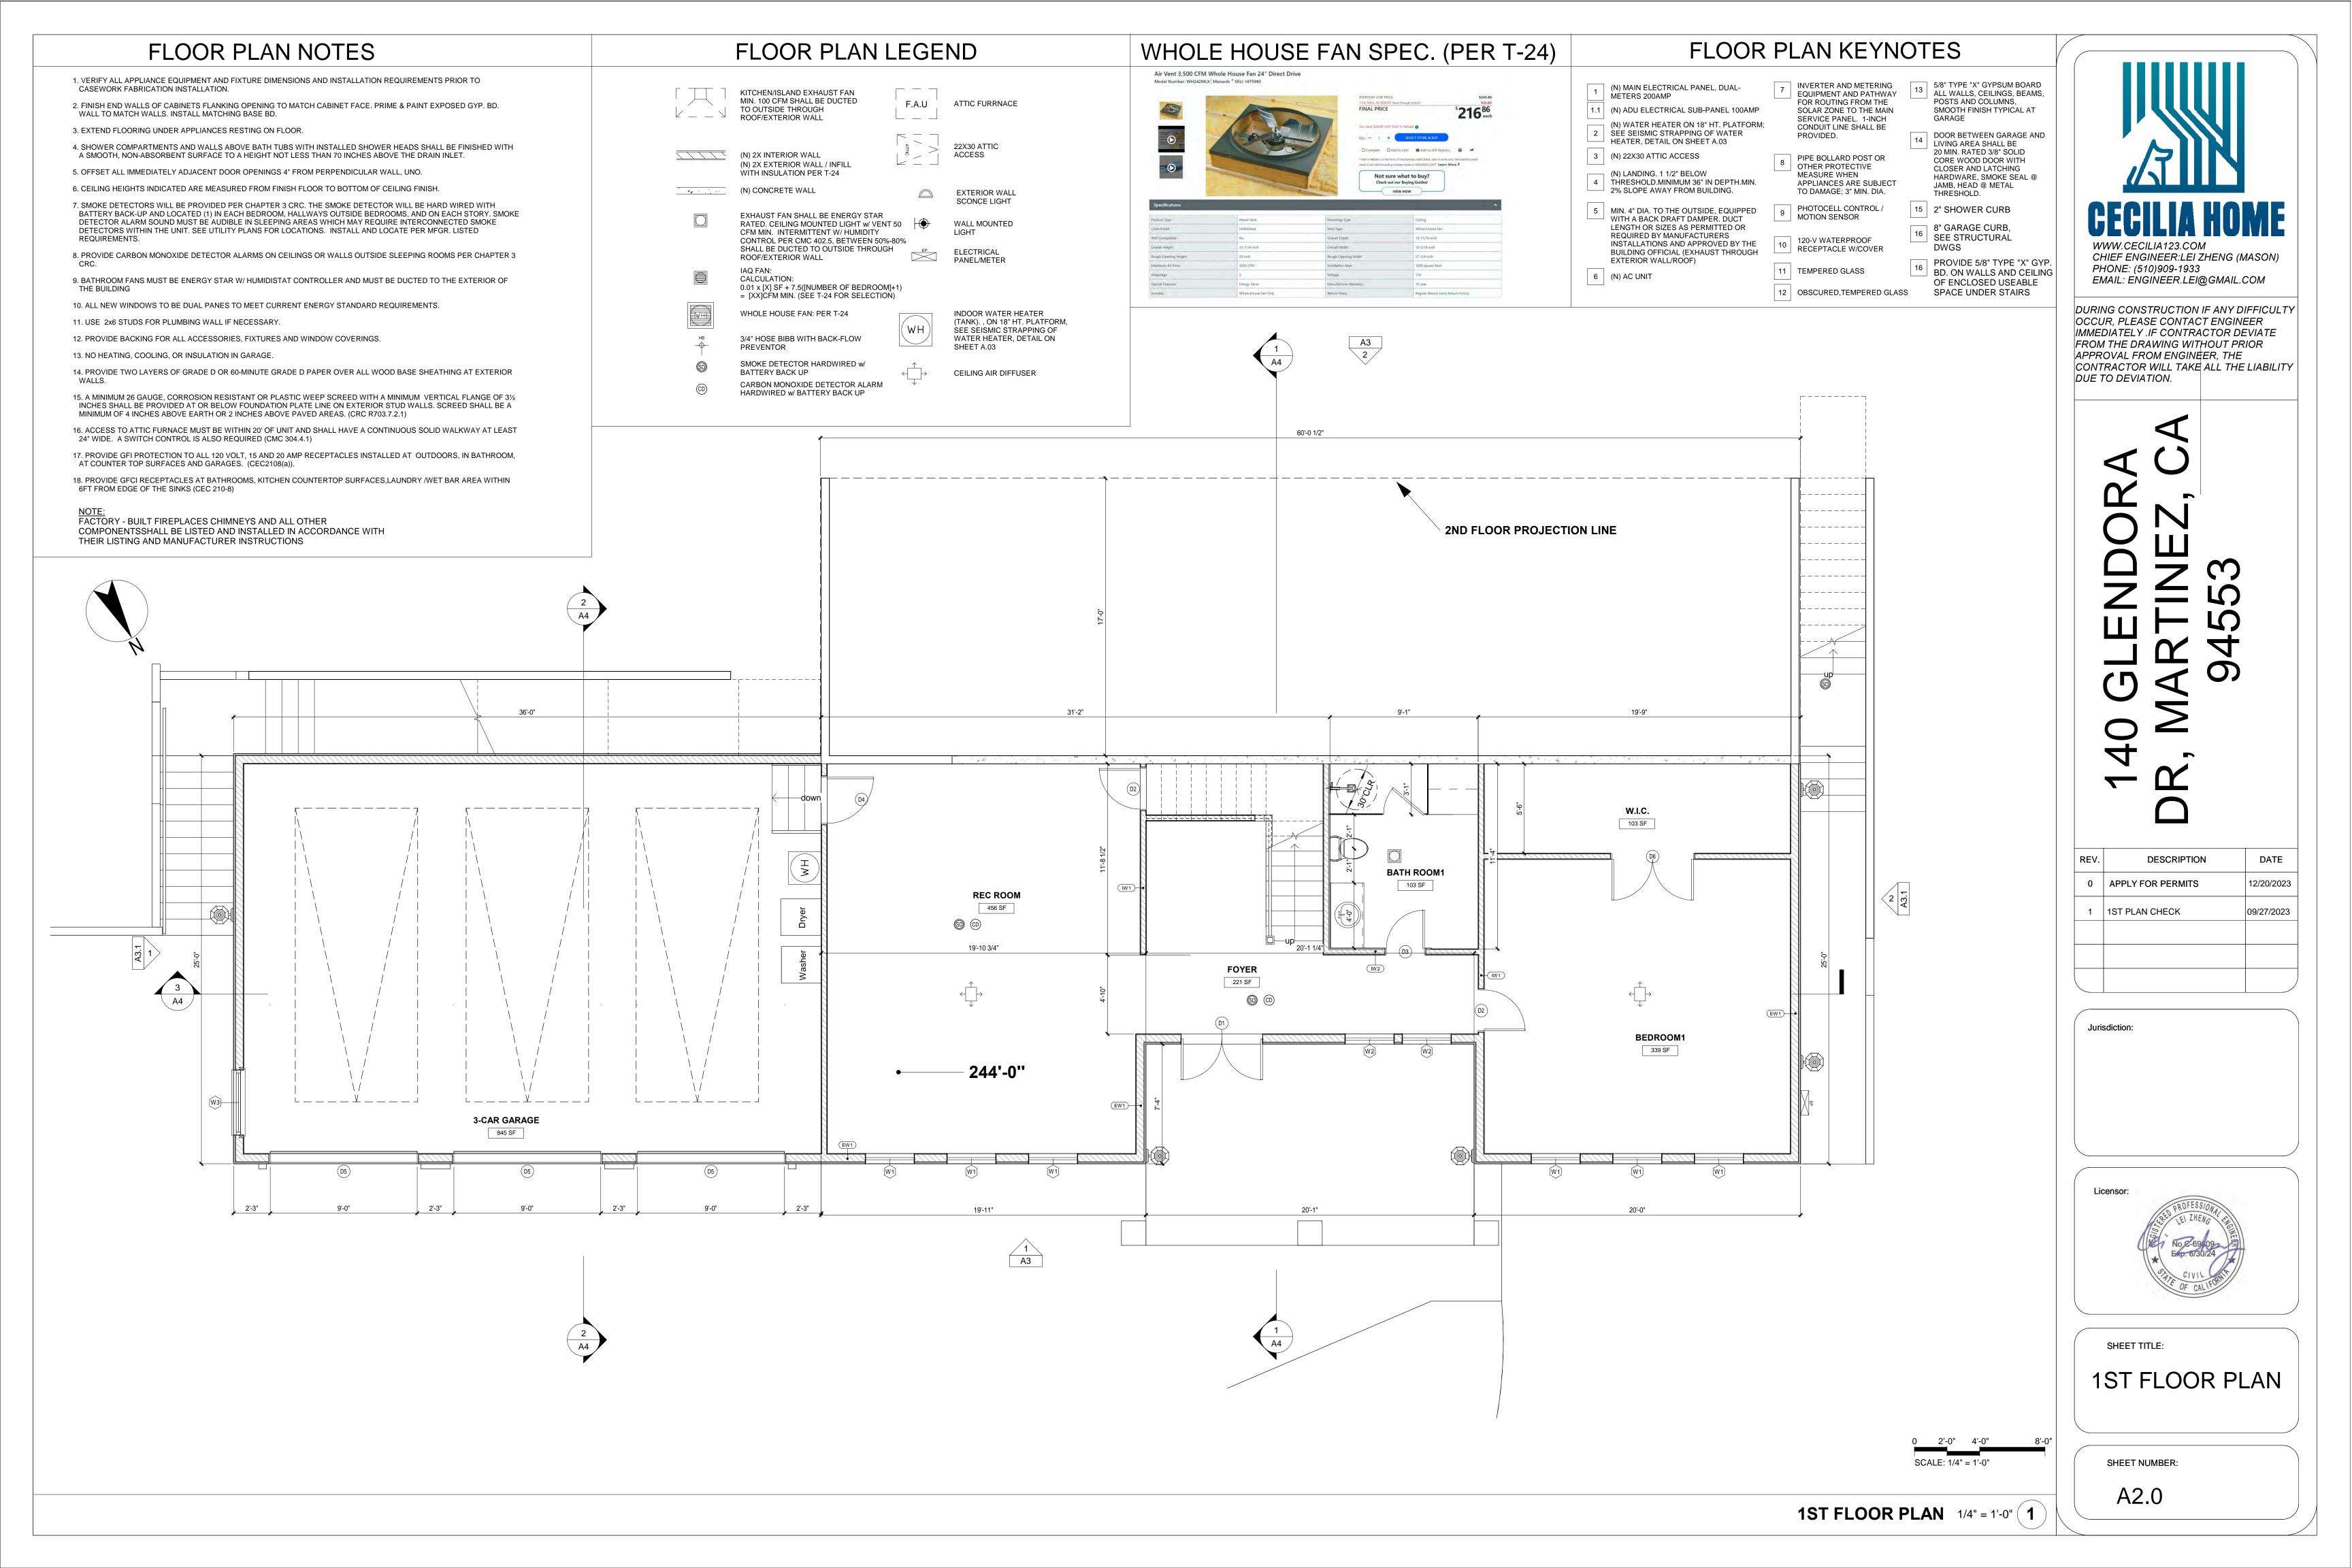

4

REV.	DESCRIPTION	DATE
0	APPLY FOR PERMITS	12/20/2023
1	1ST PLAN CHECK	09/27/2023
2	2ND PLAN CHECK	01/10/2024

Jurisdiction:

Licensor:


SHEET TITLE:

2ND FLOOR PLAN

SHEET NUMBER:

A2.1



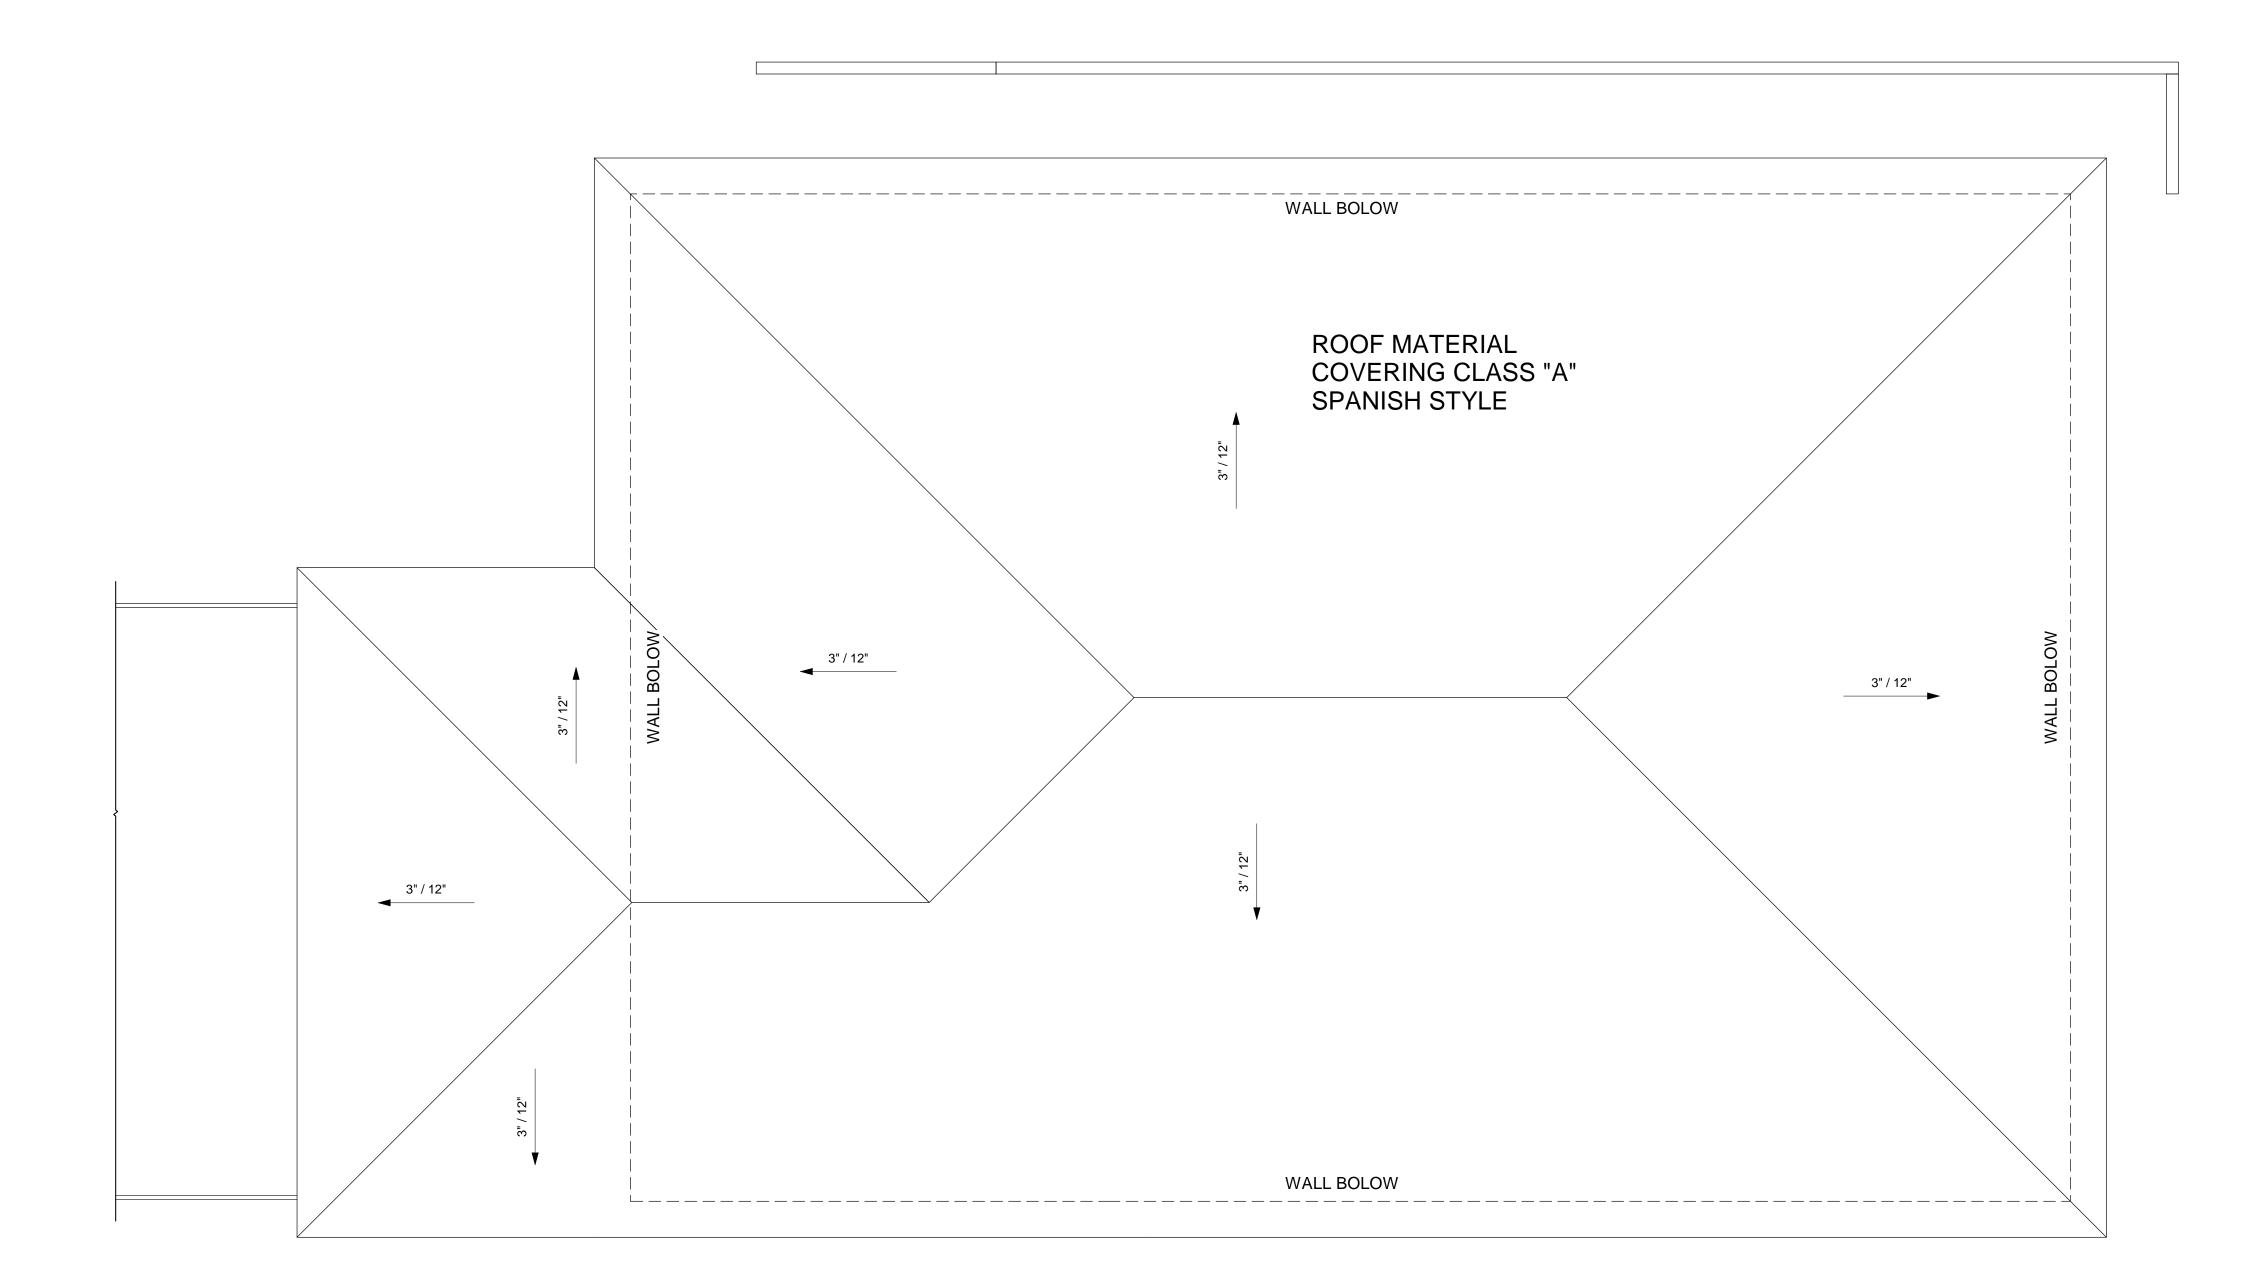

SCALE: 1/4" = 1'-0"

ROOF PLAN 1/4" = 1'-0" (**1**

ROOF VENTILATION NOTES: (CRC R806)

1. ENCLOSED ATTICS AND ENCLOSED RAFTER SPACES FORMED WHERE CEILINGS ARE APPLIED DIRECTLY TO THE UNDERSIDE OF ROOF RAFTERS SHALL HAVE CROSS VENTILATION FOR EACH SEPARATE SPACE BY VENTILATING OPENINGS PROTECTED AGAINST THE ENTRANCE OF RAIN OR SNOW. VENTILATION OPENINGS SHALL HAVE AT LEAST DIM. OF 1/16" MIN. AND 1/4" MAX. VENTILATION OPENINGS HAVING A LEAST DIMENSION LARGER THAN 1/4" SHALL BE PROVIDED W/. CORROSION-RESISTANT WIRE CLOTH SCREENING, HARDWARE CLOTH, OR SIMILAR MATERIAL WITH OPENINGS HAVING A LEAST DIM. OF 1/16" MIN. AND 1/4" MAX. OPENINGS IN ROOF FRAMING MEMBERS SHALL CONFORM TO THE REQ'TS. OF CRC R802.7. REQUIRED VENTILATION OPENINGS SHALL OPEN DIRECTLY TO THE OUTSIDE AIR.

2. THE NET FREE VENTILATING AREA SHALL NOT BE LESS THAN 1/150 OF THE AREA OF THE SPACE VENTILATED. THE NET FREE VENTILATING AREA SHALL NOT BE LESS THAN 1/300 IF ONE OR MORE OF THE FOLLOWING ARE MET: 1. IN CLIMATE ZONES 14 & 16, A CLASS I OR II VAPOR RETARDER IS INSTALLED ON THE WARM-IN-WINTER SIDE OF THE CEILING. 2. AT LEAST 40% AND MORE THAN 50% OF THE REQUIRED VENTILATING ARE IS PROVIDED BY VENTILATORS LOCATED IN THE UPPER PORTION OF THE ATTIC OR RAFTER SPACE. UPPER VENTILATORS SHALL BE LOCATED NO MORE THAN 3 FEET BELOW THE RIDGE OR HIGHEST POINT OF THE SPACE, MEASURED VERTICALLY, WITH THE BALANCE OF TEH REQUIRED VANTILATION PROVIDED BY EAVE OR CORNICE VENTS. WHERE THE LOCATION OF WALL OR ROOF FRAMING MEMBERS CONFLICTS WITH THE INSTALLATION OF UPPER VENTILATORS, INSTALLATION MORE THAN 3 FEET BELOW THE RIDGE OR HIGHEST OF THE SPACE SHALL BE PERMITTED.

3. WHERE EAVE OR CORNICE VENTS ARE INSTALLED, INSULATION SHALL NOT BLOCK THE FREE FLOW OF AIR. A MIN. OF A 1" SPACE SHALL BE PROVIDED BETWEEN THE INSULATION AND THE ROOF SHT'G. AND AT THE LOCATION OF THE VENT.

4. VENTILATORS SHALL BE INSTALLED IN ACCORDANCE WITH MFR'G.'S INSTALLATION INSTRUCTIONS. INSTALLATION OF VENTILATORS IN ROOF SYSTEMS SHALL BE IN ACCORDANCE W/. THE REQ'TS. OF SECTION R903. INSTALLATION OF VENTILATORS IN WALL SYSTEMS SHALL

BE IN ACCORDANCE W/. THE REQ'TS. OF SECTION R703.1. 5. UNVENTED ATTIC ASSEMBLIES (SPACES BETWEEN THE CEILING JOISTS OF THE TOP STORY AND THE ROOF RAFTERS) AND UNVENTED ENCLOSED RAFTER ASSEMBLIES (SPACES BETWEEN CEILINGS THAT ARE APPLIED DIRECTLY TO THE UNDERSIDE OF ROOF FRAMING

1. THE UNVENTED ATTIC SPACE IS COMPLETELY CONTAINED WITHIN THE BUILDING THERMAL

MEMBER/RAFTERS AND THE STRUCTURAL ROOF SHT'G. AT THE TOP OF THE ROOF FRAMING

MEMBERS/RAFTERS) SHALL BE PERMITTED IF ALL OF THE FOLLOWING CONDITIONS ARE MET:

2. NO INTERIOR CLASS I VAPOR RETARDERS ARE INSTALLED ON THE CEILING SIDE (ATTIC FLOOR) OF THE UNVENTED ATTIC ASSEMBLY OR ON THE CEILING SIDE OF THE UNVENTED ENCLOSED RAFTER ASEEMBLY.

3. WHERE WOOD SHINGLES OF SHAKES ARE USED, A MIN. 1/4" VENTED AIR SPACE SEPARATES THE SHINGLES OR SHAKES AND THE ROOFING UNDERLAYMENT ABOVE THE STRUCTURAL SHT'G.

4. IN CALIFORNIA CLIMATE ZONES 14 & 16, ANY AIR-IMPERMEABLE INSULATION SHALL BE A CLASS II VAPOR RETARDER, OR SHALL HAVE A CLASS III VAPOR RETARDER COATING OR COVERING IN DIRECT CONTACT W/. THE UNDERSIDE OF THE INSULATION (SEE TITLE 24, PART

5. EITHER ITEMS 5.1, 5.2 OR 5.3 SHALL BE MET, DEPENDING ON THE AIR PERMEABILITY OF THE INSULATION DIRECTLY UNDER THE STRUCTURAL ROOF SHT'G. (NO INSULATION SHALL BE REQ'D. WHEN ROOF TILES, WOOD SHINGLES OR WOOD SHAKES, OR ANY OTHER ROOFING SYSTEM USING BATTENS AND NO CONT. UNDERLAYMENT IS INSTALLED. A CONT. LAYER SHALL BE CONSIDERED TO EXIST IF SHT'G., ROOFING PAPER OR ANY CONT. LAYER WHICH HAS A PERM RATE OF NO MORE THAN ONE PERM UNDER THE DRY CUP METHOD.);

5.1. AIR-IMPERMEABLE INSULATION ONLY. INSULATION SHALL BE APPLIED IN DIRECT CONTACT W/. THE UNDERSIDE OF THE STRUCTURAL ROOF SHT'G.

5.2. AIR-PERMEABLE INSULATION ONLY. IN ADDITION TO THE AIR-PERMEABLE INSULATION INSTALLED DIRECTLY BELOW THE STRUCTURAL SHT'G., RIDGE BOARD OR SHEET INSULATION W/. AN R-VALUE OR R-4 SHALL BE INSTALLED DIRECTLY ABOVE THE STRUCTURAL ROOF SHT'G. FOR CONDENSATION CONTROL.

5.3. AIR-IMPERMEABLE AND AIR-PERMEABLE INSULATION. THE AIR-IMPERMEABLE INSULATION SHALL BE APPLIED IN DIRECT CONTACT W/. THE UNDERSIDE OF THE STRUCTURAL ROOF SHT'G. FOR CONDENSATION CONTROL. THE AIR-PERMEABLE INSULATION SHALL BE INSTALLED DIRECTLY UNDER TH AIR-PERMEABLE INSULATION.

5.4. WHERE PREFORMED INSULATION BOARD IS USED AS THE AIROIMPERMEABLE INSULATION LAYER, IT SHALL BE SEALED AT THE PERIMETER OF EACH INDIVIDUAL SHEET INTERIOR SURFACE TO FORM A CONT. LAYER.

ROOF PLAN GENERAL NOTES

- 1. ROOF MATERIAL COVERING CLASS "A" ASPHALT SHINGLES BY CERTAINTEED ICC-ESR# 3537. COLOR & PER THE INSTALLATION OF ROOF COVERING SHALL BE IN ACCORDANCE WITH MANUFACTURER'S SPECIFICATIONS.
- 2. CHIMNEY TO BE 2FT ABOVE ROOF WITHIN 10'-0" WITH SPARK ARRESTOR AND SHROUD 12" MAX. HEIGHT, TYP.

3. PROJECTIONS LESS THAN 3'-0" (HOUSE WITH SPRINKLER) OR 5'-0" (HOUSE WITH NO SPRINKLER) TO PROPERTY LINE TO BE 1-HOUR CONSTRUCTION, TYP.

4. ROOF VENT: SEE ROOF VENTILATION CALCULATION.

5. PROVIDE MIN. 2% SLOPE AT FLAT ROOF AND DECK.

ROOF VENTILATION CALCULATION

ATTIC AREA: 2426 SF USE BALANCE METHOD : NET VENT AREA REQUIRE : 2426/300 x 144 SQ.IN. = 1165 SQ.IN 1/2 OF VENT AREA WILL BE PLACED AT HIGH PART OF ROOF (EXHAUST VENT) 1/2 OF VENT AREA WILL BE PLACED AT LOW PART OF ROOF (INTAKE VENT)

LOW: USE 9 UNITS O'HAGIN VENT (72 SQ.IN/UNIT) HIGHT: USE 9 UNITS O'HAGIN VENT (72 SQ.IN/UNIT)

CHIEF ENGINEER:LEI ZHENG (MASON) PHONE: (510)909-1933 EMAIL: ENGINEER.LEI@GMAIL.COM

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REV.	DESCRIPTION	DATE
0	APPLY FOR PERMITS	12/20/2023
1	1ST PLAN CHECK	09/27/2023

Jurisdiction:



SHEET TITLE:


ROOF PLAN

SHEET NUMBER:

A2.2



Front Elevation 1/4" = 1'-0" **1**

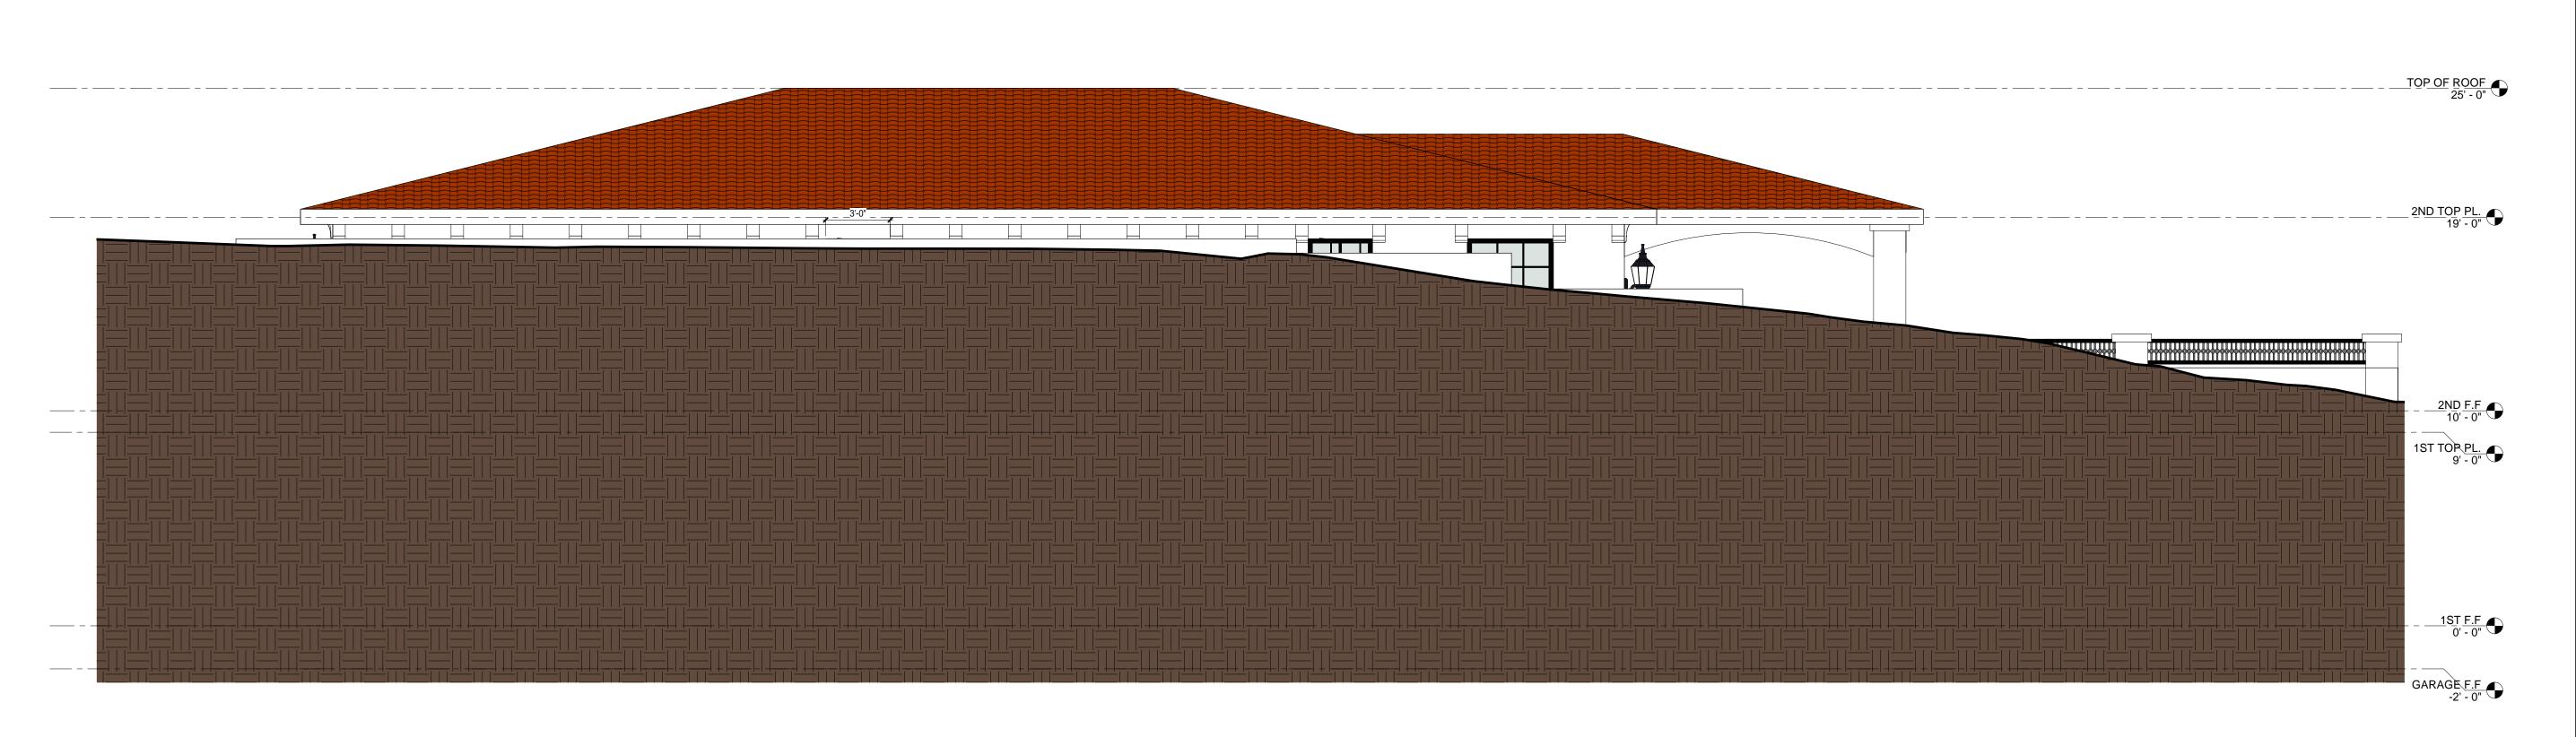

0 2'-0" 4'-0" SCALE: 1/4" = 1'-0"

Rear Elevation 1/4" = 1'-0" **2**




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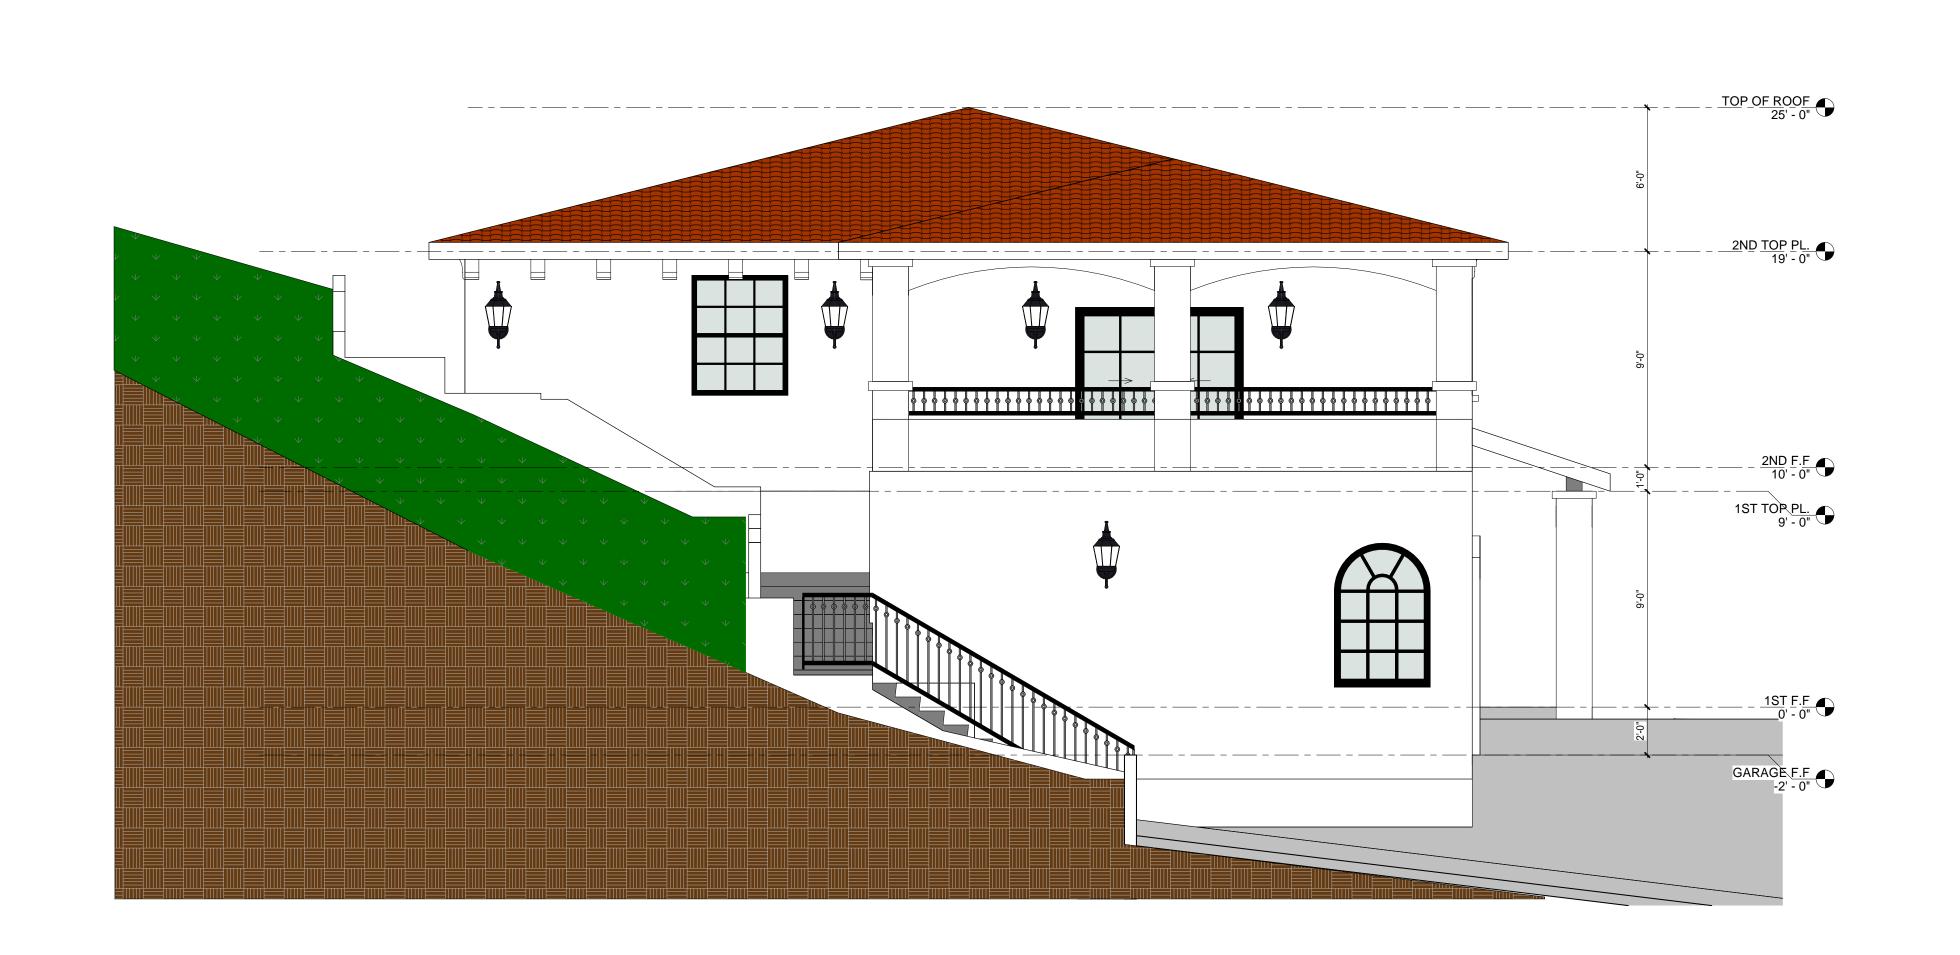



SHEET TITLE:

ELEVATIONS

SHEET NUMBER:

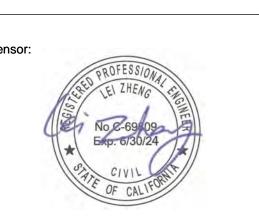A3



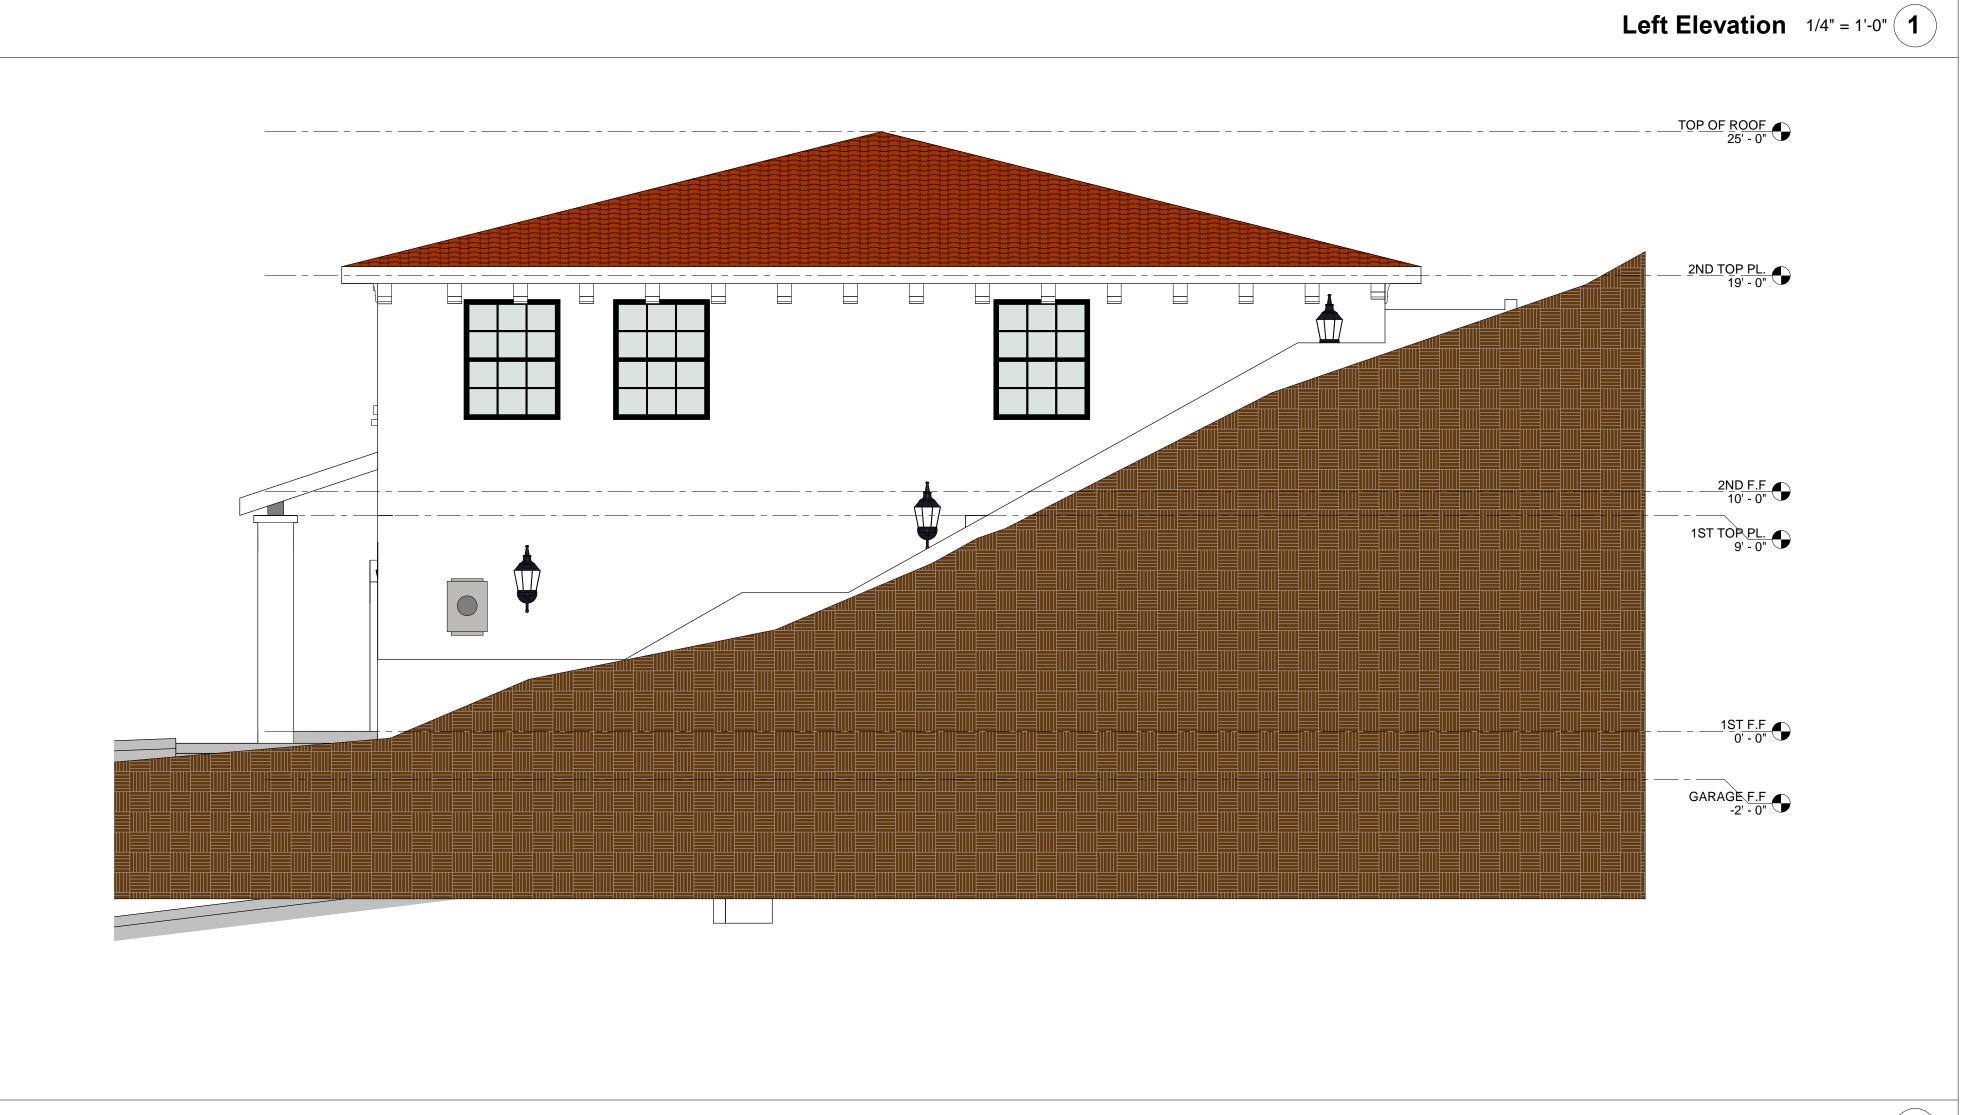

COLOR & MATERIALS BOARD

	Item	Color	Image	Material
1	Exterior Wall	White		Smooth Stucco
2	Roof	Orange		Spanish-Style Tile
3	Fascia	Polar bear 75		Paint
4	Column	White		Stucco
5	Exterior Door	Walnut		Paint
6	Interior Door	Wood, White		Vinyl, Wood (Milgard Brand)
7	Window	Black,Transparent		Vinyl, GLASS (Milgard Brand)
8	Outside Step	Concrete		Concrete

_RV2_CLOUD13a#_02182024_

EXTERIOR LIGHTING SCHEDULE

Item	Picture	Detail	Material	Total
1 Exterior Wall Lighting		Uses (1) 100- Watt max medium base bulb	East Haven Collection 1- Light Textured Black Clear Seeded Glass Transitional Outdoor Large Wall Lantern Light	11

*Note: Interior lighting fixtures depends on the electrical plan. Electrical plan will be provided later. munumunumunum Cloud 1#_01102024

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CONTRACTOR WILL TAKE ALL THE LIABILITY
DUE TO DEVIATION.

40

REV.	DESCRIPTION	DATE
0	APPLY FOR PERMITS	12/20/2023
1	1ST PLAN CHECK	09/27/2023
2	2ND PLAN CHECK	01/10/2024


SHEET TITLE:


ELEVATIONS

SHEET NUMBER:

A3.1

Right Elevation 1/4" = 1'-0" **2**

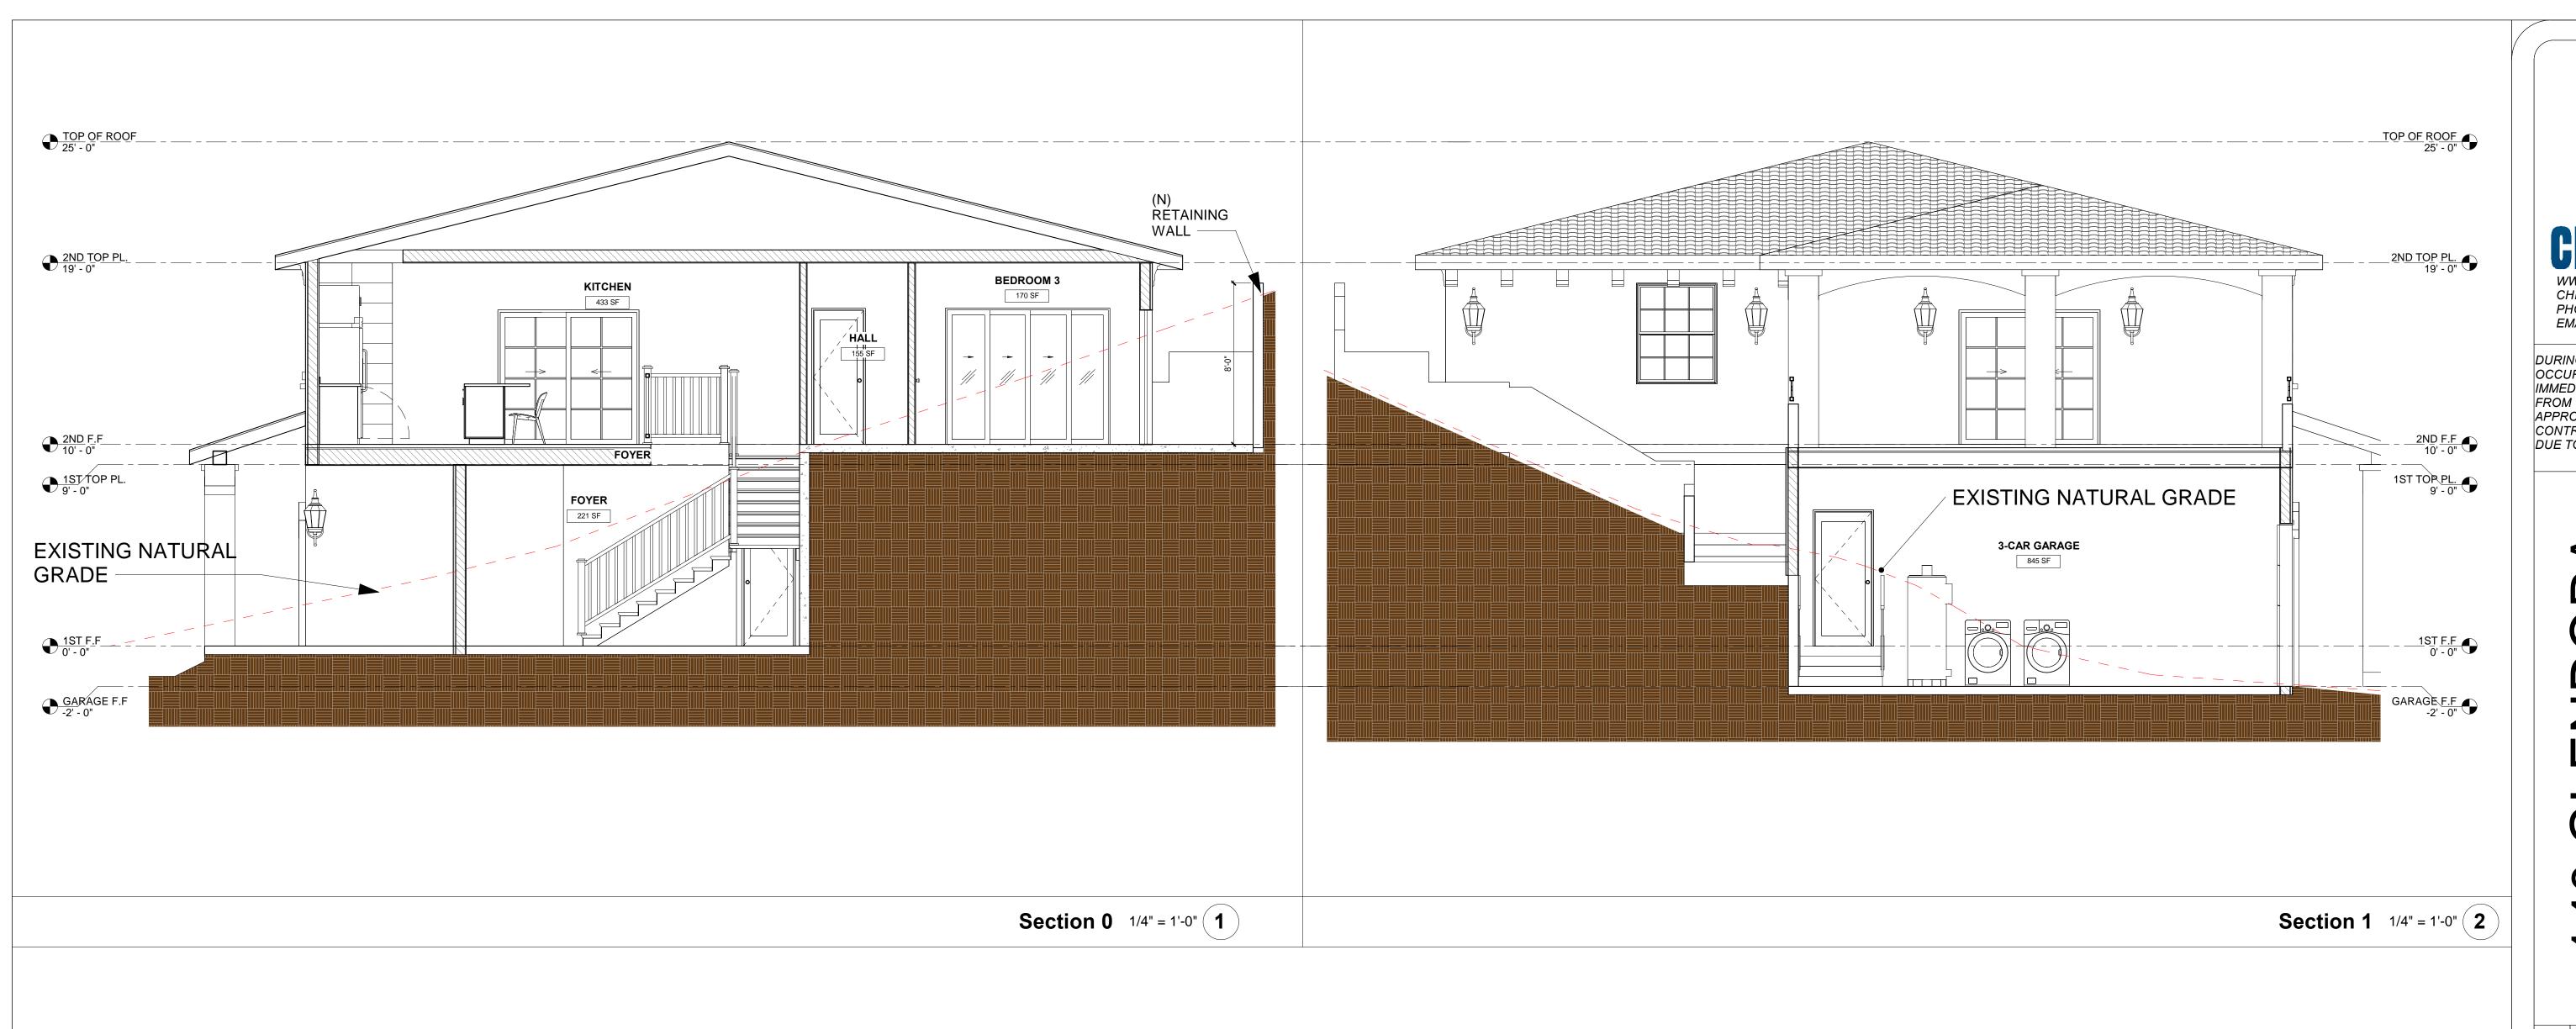

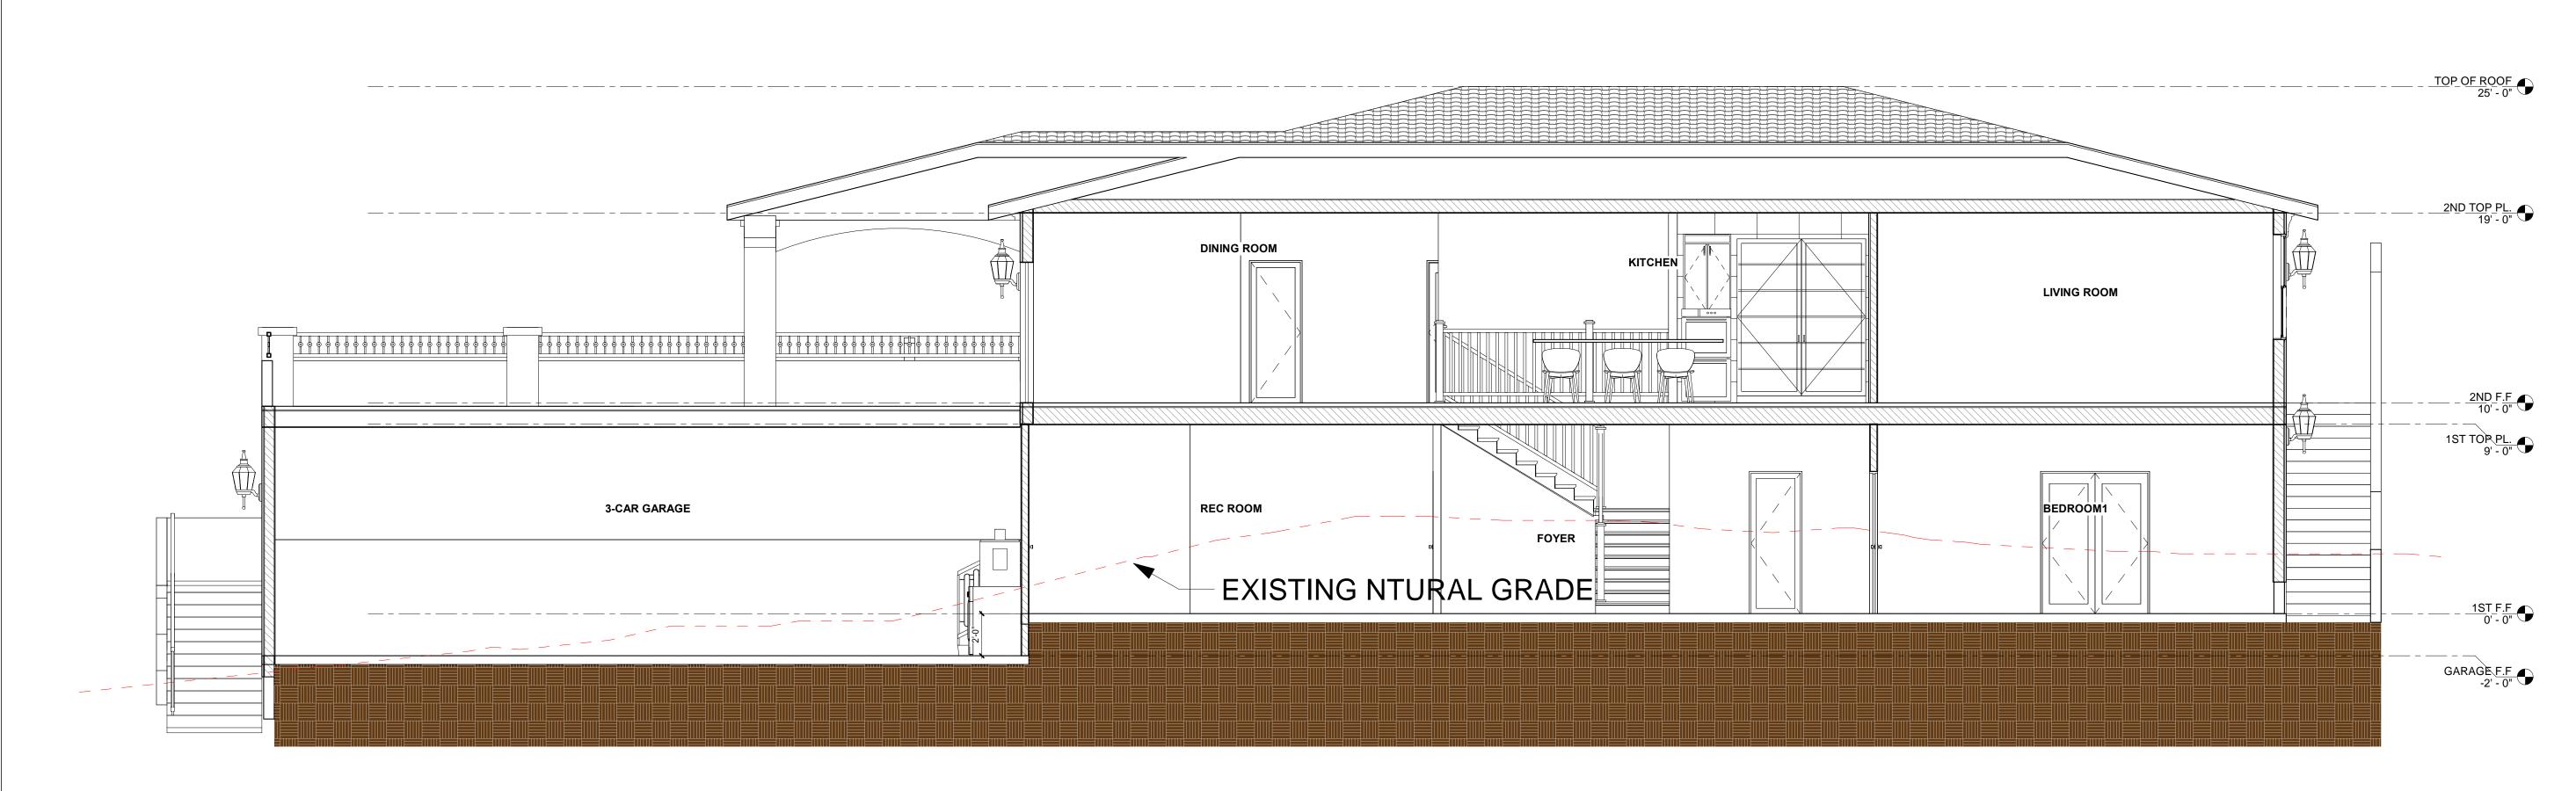

0 2'-0" 4'-0" 8'-SCALE: 1/4" = 1'-0"

Section 2 1/4" = 1'-0" (3)



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140 GLENDORA DR, MARTINEZ, CA 94553

	REV.	DESCRIPTION	DATE
	0	APPLY FOR PERMITS	07/03/23
	1	1ST PLAN CHECK	09/27/2023
	2	2ND PLAN CHECK	01/10/2024

Jurisdiction:




SHEET TITLE:

SECTIONS

SHEET NUMBER:


A4

DOOR ELEVATION & SCHEDULE

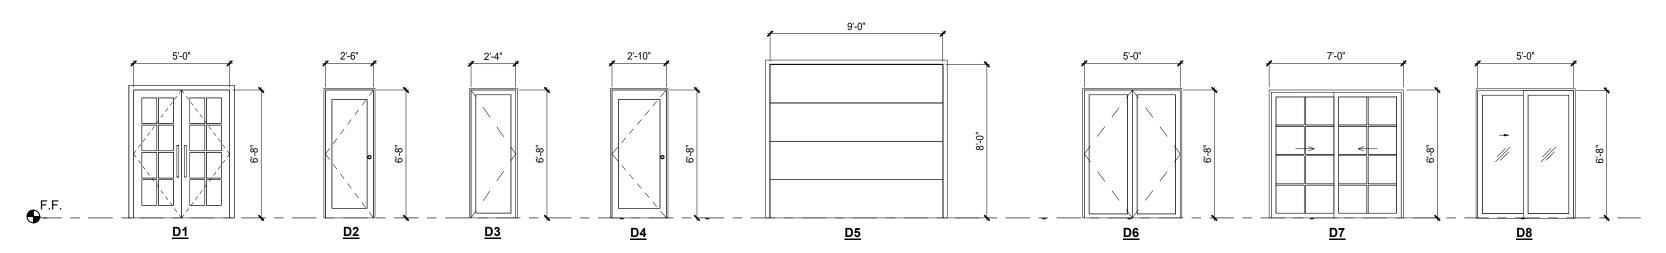

NUMBER	DOOR SIZE	QTY	DESCRIPTION	HEAD HEIGHT
D1	5' - 0" x 6' - 8"	1	Front Entry Door, Wood Frame/Glass Panel, See Elev.	6' - 8"
D2	2' - 6" x 6' - 8"	5	Interior Door, Bedroom, Wood Frame/Panel, See Elev.	6' - 8"
D3	2' - 4" x 6' - 8"	3	Interior Door, Bathroom, Wood Frame/Panel, See Elev.	6' - 8"
D4	2' - 10" x 6' - 8"	1	Interior Door, Wood Frame/Panel, Garage Door	6' - 8"
D5	9' - 0" x 8' - 0"	3	GARAGE DOOR	8' - 0"
D6	5' - 0" x 6' - 8"	1	Interior Door, Closet Door, Wood Frame/Panel, See Elev.	6' - 8"
D7	7' - 0" x 6' - 8"	3	Exterior Sliding Door, Bedroom/ Living Room, Wood Frame/ Glass Panel, See Elev.	6' - 8"
D8	5' - 0" x 6' - 8"	1	Interior Sliding Doo ,Bedroom, Wood Frame/Panel, See Elev.	6' - 8"
Grand total: 1	8			

WINDOW ELEVATION & SCHEDULE

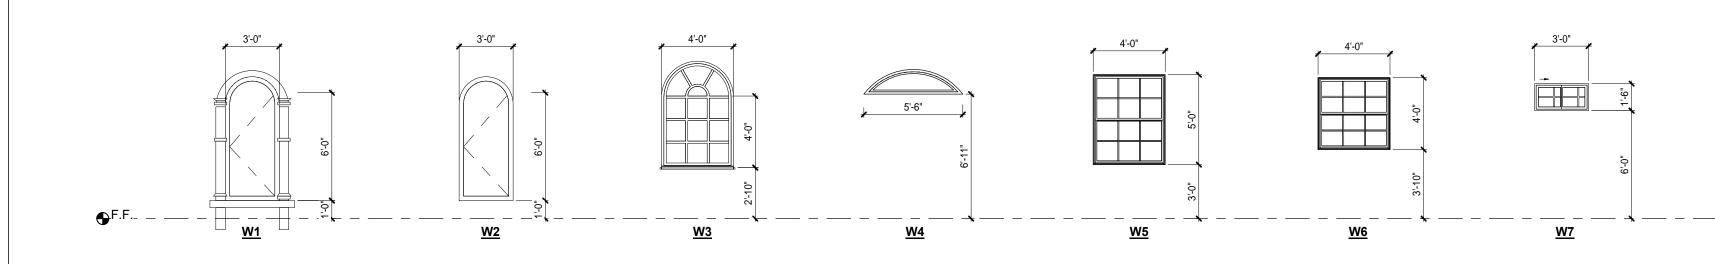

ID	QTY	WINDOW SIZE	DESCRIPTION	SILL HEIGHT	HEAD HEIGHT
W1	6	3' - 0" x 6' - 0"	Casement Window, Aluminium Frame/ Glass Panel, Radius Top, See Elev.	1' - 0"	7' - 0"
W2	2	3' - 0" x 6' - 0"	Casement Window, Aluminium Frame/ Glass Panel, Radius Top, See Elev.	1' - 0"	7' - 0"
W3	1	4' - 0" x 4' - 0"	Casement Window, Aluminium Frame/ Glass Panel, Radius Top, See Elev.	2' - 10"	6' - 10"
W4	1	5' - 6" x -	Fixed Window, Aluminium Frame/ Glass Panel, Radius Top, See Elev.	6' - 11"	
W5	12	4' - 0" x 5' - 0"	Single Hung, Dual Glass/ Fiberglass Frame, Finish Per Elev.	3' - 0"	8' - 0"
W6	1	4' - 0" x 4' - 0"	Single Hung, Dual Glass/ Fiberglass Frame, Finish Per Elev.	3' - 10"	7' - 10"
W7	2	3' - 0" x 2' - 0"	SLIDER, TEMPERED GLASS/ FIBERGLASS FRAME, SOLID CORE, FINISH PER MFGR.	6' - 0"	8' - 0"

DOOR/WINDOW NOTES

- 1. ALL DOORS AND WINDOWS SHALL MEET CITY'S SECURITY ORDINANCE.
- 2. ALL EXTERIOR DOORS & WINDOWS SHALL BE WEATHER TIED AND PROVIDE WITH INSECT SCREEN-METAL. DOORS & WINDOWS SHALL BE IN COMPLIANCE WITH ANSI. STD. A13 OR A1342.
- 3. THE MANUFACTURED WINDOWS AND SLIDING DOOR SHALL HAVE A LABEL ATTACHED CERTIFIED BY THE NATIONALS FENESTRATION RATING COUNCIL (NFRC) AND COMPLIANCE WITH THE ENERGY CALCULATIONS.
- 4. THE LOAD RESISTANCE OF GLASS UNDER UNIFORM LOAD SHALL BE DETERMINED IN ACCORDANCE WITH ASTM E1300.
- 5. ALL TEMPERED GLASS (T.G.) SHALL BE ACID-ETCHED, SAND-BLASTED, CERAMIC-FIRED, LASER-ETCHED, OR EMBOSSED PER CRC 2406.3.
- NIBOSSED PER CRC 2406.3.
- 6. GLAZING AND INSULATION SHALL CONFORM TO THE STATE ENERGY INSULATION STANDARD.7. DEAD BOLT LOCKS ARE REQUIRED ON ALL EXTERIOR DOORS (INCLUDING HOUSE TO GARAGE)
- 8. GLAZING SHALL BE SAFETY GLAZING IF LESS THAN 72" ABOVE BATHROOM FINISH FLOOR
- 9. SLIDING GLASS DOORS AND WINDOWS LOCATED LESS THAN 16 FEET ABOVE ANY SURFACE AVAILABLE FOR USE BY THE PUBLIC SHALL BE CAPABLE OF BEING LOCKING SECURELY. MOVEABLE PANELS SHALL NOT BE EASILY REMOVED FROM THE FRAME.
- 10. ALL MAIN OR FRONT ENTRY TO DWELLINGS SHALL BE ARRANGED SO THAT THE OCCUPANT HAS A VIEW OF THE AREA IMMEDIATELY OUTSIDE WITHOUT OPENING DOOR. SUCH VIEW MAY BE POVIDED BY A DOOR VIEW, A VIEW PORT, WINDOW, OR OTHER OPENING.
- 11. ALL SWINGING DOORS SHALL BE EQUIPPED WITH A DEAD BOLT WITH A MINIMUM THROW OF 1 INCH AND AN EMBEDMENT OF NOT LESS THAN 5/8 INCH.
- 12. THE INACTIVE LEAF OF A PAIR OF DOORS AND THE UPPER LEAF OF DUTCH DOORS SHALL BE EQUIPPED WITH A DEAD BOLT.
- 13. NON-REMOVABLE PINS SHALL BE USED IN PIN TYPE HINGES WHICH ARE ACCESSIBLE FROM THE OUTSIDE WHEN THE DOOR IS CLOSED.
- 14. UNFRAMED GLASS DOORS SHALL BE FULLY TEMPERED GLASS NOT LESS THAN 1/2" THICK.
- 15. NARROW-FRAMED GLASS DOORS SHALL BE FULLY TEMPERED GLASS NOT LESS THAN 1/4" THICK.
- 16. ANY GLASS WHICH IS LOCATED WITHIN 40 INCHES OF THE BLOCKING DEVICE ON A DOOR SHALL BE FULLY TEMPERED, OR HAVE APPROVED METAL BARS, SCREENS OR GRILLS.
- 17. IT IS CONTRACTOR'S RESPONSIBILITY TO CONFIRM DOOR/WINDOW ROUGH OPENING DIMENSIONS WITH THE MANUFACTURE/SUPPLIER PRIOR TO BEGIN CONSTRUCTION
- 18. AUTOMATIC GARAGE DOOR OPENERS, IF PROVIDED, SHALL BE LISTED IN ACCORDANCE WITH UL 325. (R309.4)
- 19. EMERGENCY EGRESS:
- A. MIN. SET CLEAR OPENING OF 5.7 SQUARE FEET.
- B. MIN. SET CLEAR HEIGHT OF 24 INCHES.
- C. WINDOW SILL CLEAR OPENING EMERGENCY EGRESS NO MORE THAN 44 INCHES ABOVE THE FLOOR.



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	REV.	DESCRIPTION	DATE
	0	APPLY FOR PERMITS	07/03/23
	1	1ST PLAN CHECK	09/27/2023
	2	2ND PLAN CHECK	01/10/2024

Jurisdiction

Licensor:



SHEET TITLE:

DOOR/WINDOW ELEVATION & —SCHEDULE—

SHEET NUMBER:

A5



Preparing a Stormwater Control Plan for a Small Land Development Project

square feet for one single-family residence that is not a part of a larger plan of development)

The template is available in Word format on the Contra Costa Clean Water Program website.

Preparing a

Stormwater Control Plan

for a Small Land Development Project

Development projects that create or replace 2,500 square feet or more of impervious surface (roofs or pavement) must incorporate one or more specified measures to reduce runoff. The type and extent of runoff-reduction measures required for any specific project will be determined by local staff consistent with a maximum extent practicable standard.

Projects that create or replace 5,000 square feet or more (the threshold is 10,000 square feet or more for one single-family home that is not part of a larger plan of development) of impervious surface are "Regulated Projects," and require a more comprehensive Stormwater Control Plan. See the Contra Costa Clean Water Program (CCCWP) Stormwater C.3 Guidebook.

These requirements are part of municipalities' comprehensive effort to reduce runoff pollution. The "Small Projects" requirement is mandated by Provision C.3.i. in the California Regional Water Quality Control Board for the San Francisco Bay Region's Municipal Regional Stormwater Permit.

It is fairly easy to achieve compliance with the stormwater requirements for small land development projects. Compliance for each project must be carefully documented. Please complete the following form and submit it as directed by municipal staff.

► STEP-BY-STEP INSTRUCTIONS

- 1. Fill out the Project Data Form (below) and select one or more runoff reduction measures.
- 2. Prepare a site plan or sketch. Specify and design the runoff reduction measures you will use to meet the stated minimum requirements.
- 3. Complete your submittal, which will include: Project Data Form
 - Site Plan or Sketch
 - Completed checklist for each Runoff Reduction Measure selected

APPENDIX O 8th Edition — DECEMBER 23, 2022

▶ STEP 2: DELINEATE IMPERVIOUS AREAS AND LOCATIONS OF RUNOFF REDUCTION MEASURES

▶ STEP 1: PROJECT DATA FORM AND RUNOFF REDUCTION MEASURE SELECTION

140 Glendora Dr, Martinez, CA 94553

140 Glendora Dr, Martinez, CA 94553

1. Disperse runoff to vegetated area

4. Bioretention Facility or Planter Box

Flow-through planter built into a hillside. Flows from

the underdrain and overflow must be directed in

accordance with local requirements.

☐ 2. Pervious pavement

☐ 3. Cisterns or Rain Barrels

03/04/2024

APN:370-140-003

OWNER: Joel Diaz

Single Family Residence

436,907 SF

9,071 SF

12,254 SF

Complete all fields.

Project Location

Project Name/Number

Application Submittal Date

[to be verified by municipal staff]

Name of Owner or Developer

Project Type and Description

Addition," "Retail and Parking"]

Total Project Site Area (acres)

with new impervious surfaces

[Street Address if available, or intersection and/or

[Examples: "Single Family Residence," "Parking Lot

Total New Impervious Surface Area (square feet)

Sum of currently pervious areas that will be covered

Total Replaced Impervious Surface Area

covered with new impervious surfaces.]

Total Pre-Project Impervious Surface Area

Total Post-Project Impervious Surface Area

Runoff Reduction Measures Selected

(Check one or more)

[Sum of currently impervious areas that will be

Delineate the impervious area. On a site plan or sketch, show the impervious area—for example, a roof, or portion of a roof, or a paved area—that will drain to your runoff reduction measure. Typically these delineations follow roof ridge lines or grade breaks. Alternatively, show the type and extent of pervious paving. An example sketch is attached.

C-2 APPENDIX C 8th Edition — DECEMBER 23, 2022

Option 4: Bioretention Facility or Planter Box

An above-ground planter box may be appropriate if the development site lacks level landscaped areas for dispersion and pervious pavements are not practical. Planter boxes and bioretention facilities can treat runoff from impervious surfaces 25 times their area (sizing factor of 0.04).

Detailed design guidance for planter boxes and bioretention areas is in the CCCWP Stormwater C.3 Guidebook.

Show on your site plan:

- ☐ Impervious areas tributary to the planter box.
- ☐ Location and footprint of planter box.

Confirm the following standard specifications are met:

- Reservoir depth is 4 to 6-inch minimum.
 - ☐ 18-inch depth soil mix with minimum long-term infiltration rate of 5 inches per hour. See Stormwater C.3 Guidebook - Contra Costa Clean Water Program (cccleanwater.org) for a list of soil mix suppliers.
 - ☐ Surface area of soil mix is a minimum 0.04 times the tributary impervious area.
 - ☐ "Class 2 perm" drainage layer 12 inches deep.
 - ☐ No filter fabric.
 - ☐ Perforated pipe (PVC SDR 35 or approved equivalent) underdrain with outlet located flush or nearly flush with planter bottom.
 - ☐ Connection with sufficient head to storm drain or discharge point.
 - ☐ Underdrain has a clean-out port consisting of a vertical, rigid, non-perforated PVC pipe, connected to the underdrain via a sweep bend, with a minimum diameter of 4 inches and a
 - Overflow outlet connected to a downstream storm drain or approved discharge point.
 - ☐ Planter is set level.
 - ☐ Emergency spillage will be safely conveyed overland.
 - ☐ Plantings are suitable to the climate, exposure, and a well-drained soil.
 - ☐ Irrigation system with connection to water supply, on a separate zone.

Indicate the location and kind of runoff reduction measure you have selected. At least one option, designed to manage runoff from some amount of impervious area—or to avoid creating

For each option selected, there is a brief checklist to confirm your design and your submittal meet minimum requirements.

► STEP 3: COMPLETE AND SUBMIT YOUR PLAN

Consult with municipal staff about when and how to submit your Stormwater Control Plan for

Option 1: Disperse runoff from roofs or pavement to vegetated areas.

This is the simplest option. Downspouts can be directed to vegetated areas adjacent to buildings, or extended via pipes to reach vegetated areas further away. Paved areas can be designed with curb cuts, or without curbs, to direct flow into surrounding vegetation.

Connecting a roof leader to a vegetated area. The

roof drainage some distance away from

head from the eave height makes it possible to route

C-3

On the site plan, show:

runoff—is required.

- Each impervious area from which runoff will be directed, and its square footage.
- The vegetated areas that will receive runoff, and the approximate square footage of each.
- If necessary, explain in notes on the plan how runoff will be routed from impervious surfaces to vegetated

Confirm the following standard specifications are met:

- Tributary impervious square footage in no instance exceeds twice the square footage of the receiving pervious area.
- downspouts. Paved areas are sloped so drainage is routed to the receiving pervious area.

Roof areas collect runoff and route it to the receiving pervious area via gutters and

- Runoff is dispersed across the vegetated area (for example, with a splash block) to avoid
- erosion and promote infiltration. Vegetated area has amended soils, vegetation, and irrigation as required to maintain soil stability and permeability.
- Any drain inlets within the vegetated area are at least 3 inches above surrounding grade.

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Useful Resource

- specifications in this supplement to the Stormwater C.3 Guidebook.
- Start At the Source: Design Guidance Manual for Stormwater Quality. Bay Area Stormwater Management Agencies Association, 1999.
- Slow It, Spread It, Sink It: A Homeowner's Guide to Turning Runoff into a Resource. Resource Conservation District of Santa Cruz County.
- National Ready Mix Concrete Association
- Interlocking Concrete Pavement Institute
- http://www.icpi.org/ Porous Pavements, by Bruce K. Ferguson. 2005. ISBN 0-8493-2670-2

The following references may be useful for design. Designs must meet the minimum standard

- Contra Costa Clean Water Program Stormwater C.3 Guidebook. Available at Stormwater C.3 Guidebook Contra Costa Clean Water
- Available at Foreword (cccleanwater.org)
- 2nd Ed., 2015. https://www.rcdsantacruz.org/images/brochures/pdf/HomeDrainageGuide.v25.pdf
- http://www.perviouspavement.org/

Licensor:

Jurisdiction:



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4

DESCRIPTION

0 APPLY FOR PERMITS

1ST PLAN CHECK

2ND PLAN CHECK

DATE

07/03/23

09/27/2023

01/10/2024

IMMEDIATELY .IF CONTRACTOR DEVIATE

PHONE: (510)909-1933

SHEET TITLE:

CONTROL PLAN1

SHEET NUMBER:



Instructions and template for preparing a submittal for a project creating or replacing more than 2,500 square feet but less Than 5,000 square feet of impervious area (10,000

8th Edition - DECEMBER 23, 2022

This option can be easy to install and maintain, cost-effective, and can add aesthetic value to your project. Permeable pavements may include pervious concrete, pervious asphalt,

Show on your site plan:

☐ No erodible areas drain on to permeable pavement.

☐ Subgrade compaction is minimal.

Reservoir base course is of open-graded crushed stone. Base depth is adequate to retain

☐ No subdrain is included or, if a subdrain is included, outlet elevation is a minimum of 3 inches above bottom of base course.

☐ Subgrade is uniform and slopes are not so steep that subgrade is prone to erosion.

□ Solid unit pavers, if used, are set in sand or gravel with minimum 3/8-inch gaps between the

Permeable concrete or porous asphalt, if used, are installed by industry-certified professionals according to the vendor's recommendations.

pavers. Joints are filled with an open-graded aggregate free of fines.

☐ Selection and location of pavements incorporates Americans with Disabilities Act requirements (if applicable), site aesthetics, and uses.

Option 2: Permeable Pavement

porous pavers, crushed aggregate, open pavers with grass or plantings, open pavers with gravel, or solid pavers.

☐ Location, extent and types of pervious pavements. Confirm the following standard specifications are met:

rainfall (3 inches is adequate) and support design loads (more depth may be required).

☐ Rigid edge is provided to retain granular pavements and unit pavers.

Option 3: Cisterns or Rain Barrels

Use of cisterns or rain barrels to comply with this requirement is subject to municipality approval. Planning and Building Permits may be required for larger systems.

Show on your site plan:

☐ Impervious areas tributary to each cistern or rain barrel.

☐ Location of each cistern or rain barrel.

Confirm the following standard specifications are met:

Rain barrels are sited at grade on a sound and level surface at or near gutter downspouts.

1/4-inch-minimum corrosion-resistant metallic hardware fabric.

☐ Water collected will be used for irrigation only. \square Openings are screened with a corrosion-resistant metallic fine mesh (1/16 inch or smaller) to

prevent mosquito harborage.

☐ The Contra Costa Mosquito and Vector Control District (District) is informed of the installation. The District will be provided additional information and/or rights of entry if

☐ Large openings are secured to prevent entry by children. ☐ Rain barrels and gutters are to be cleaned annually.

Gutters tributary to rain barrels are screened with a leaf guard or maximum 1/2-inch to

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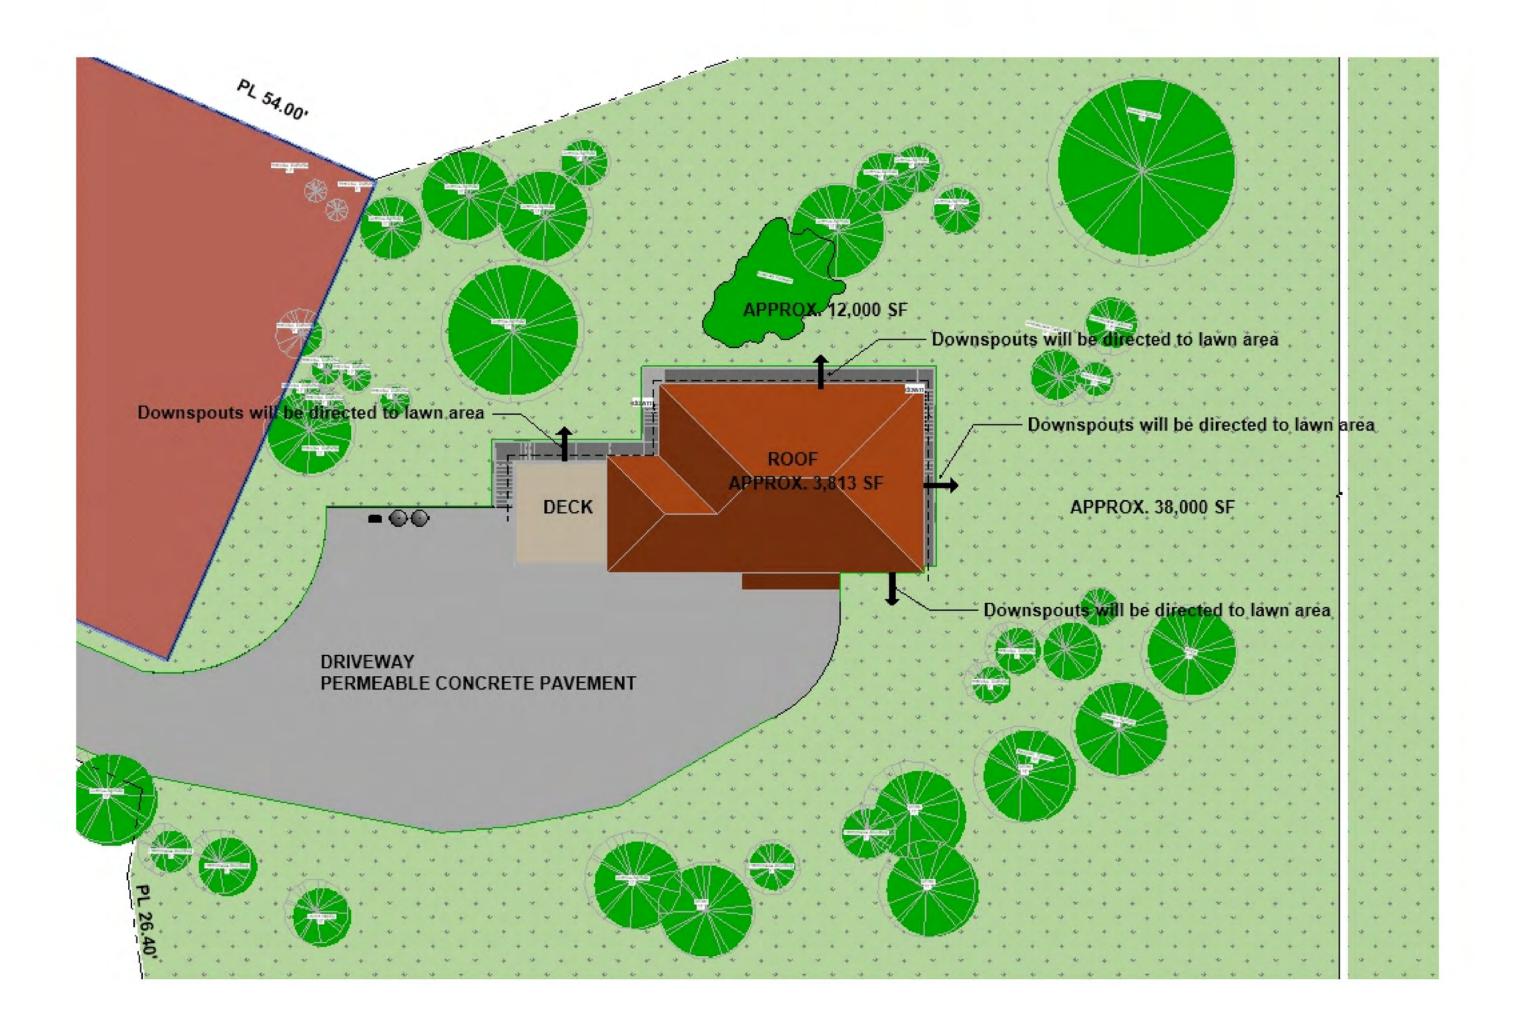
3th Edition — DECEMBER 23, 2022

8th Edition — DECEMBER 23, 2022

STORMWATER

Stormwater Control Sketch

Not to Scale





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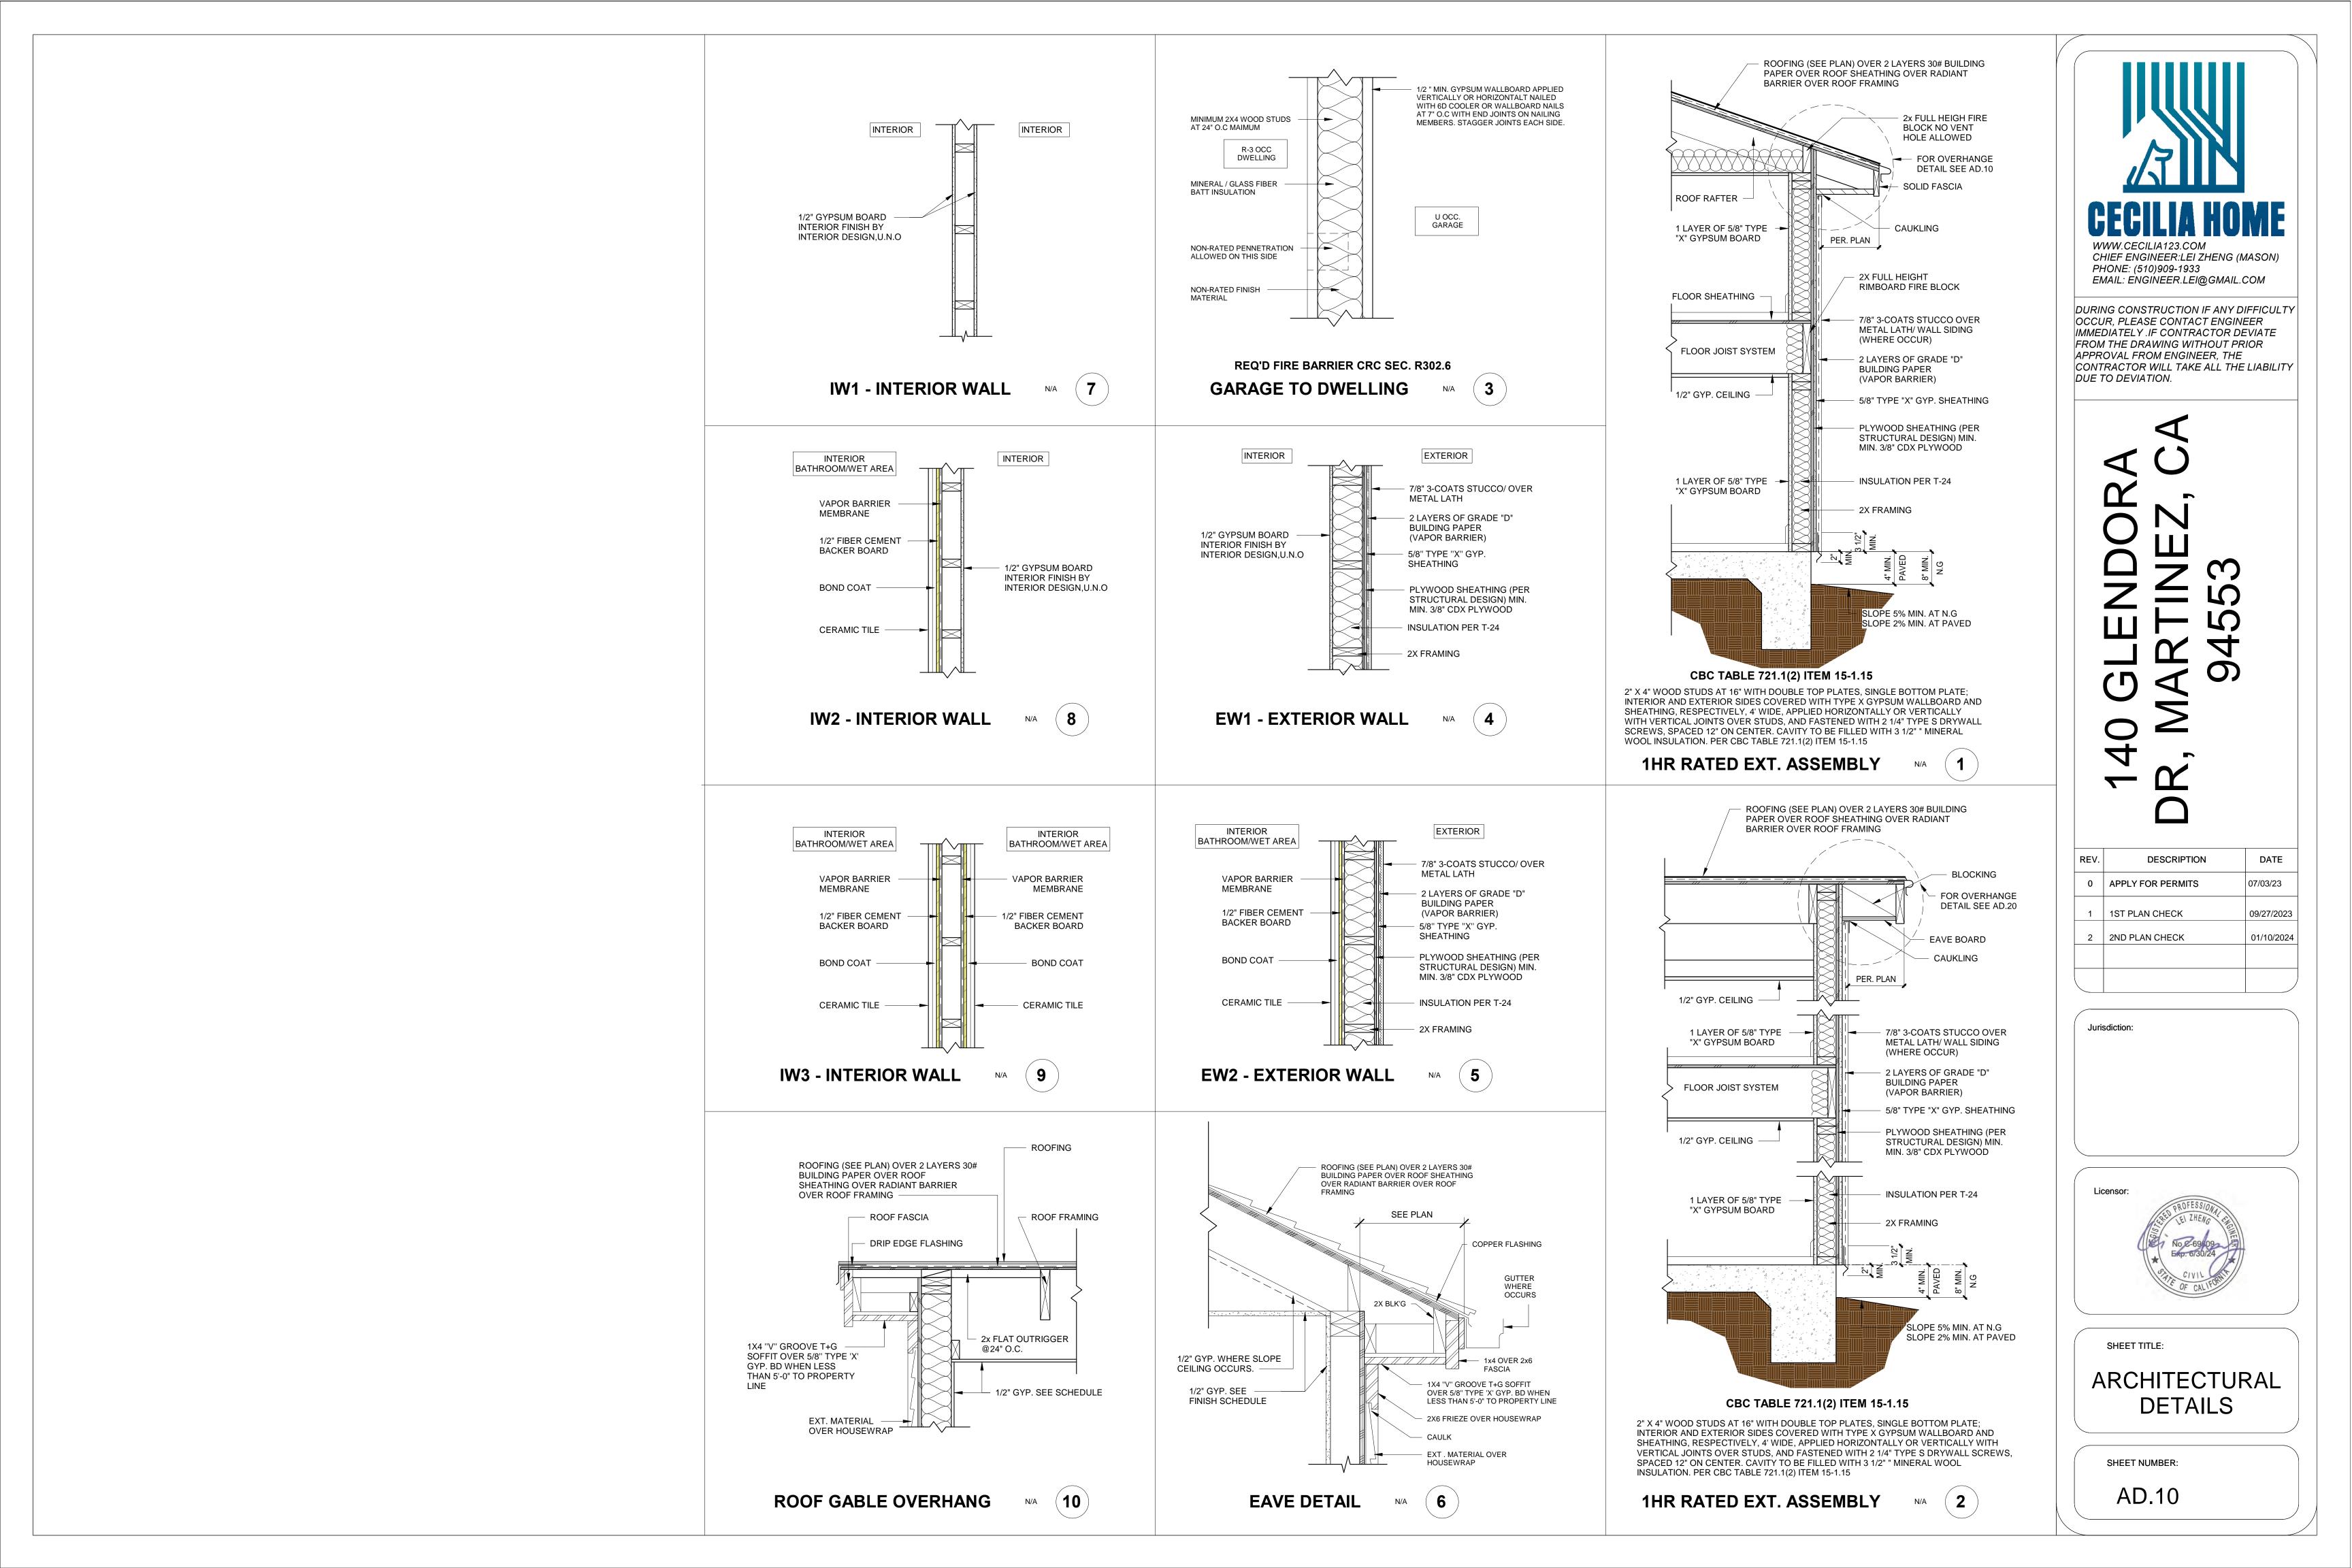


SHEET TITLE:

STORMWATER CONTROL PLAN2

SHEET NUMBER:

A6.1



PRECISE GRADING PLAN

SINGLE-FAMILY RESIDENCE

140 GLENDORA DR, MARTINEZ, CA 94553

GENERAL NOTES

- 1. ALL WORK SHALL CONFORM TO THE LATEST EDITION OF APWA STANDARD SPECIFICATION FOR PUBLIC WORKS CONSTRUCTION (GREEN BOOK) AND THE CITY OF MARTINEZ STANDARD SPECIAL PROVISIONS AND STANDARD DRAWINGS.
- 2. THE CONTRACTOR SHALL COMPLY WITH ALL STATE, COUNTY AND CITY LAWS AND ORDINANCES RELATING TO SAFETY AND CHARACTER OF WORK, EQUIPMENT AND LABOR PERSONNEL. THIS SHALL INCLUDE, BUT IS NOT LIMITED TO, THE SHORING OF TRENCHES, THE VENTILATION OF CONFINED SPACES, CONFORMANCE TO THE WATCH MANUAL FOR TRAFFIC CONTROL INCLUDING THE PROVISION AND MAINTENANCE OF BARRICADES, AND THE PREPARATION OF A TRAFFIC CONTROL PLAN AS REQUIRED.
- 3. A CITY ENCROACHMENT PERMIT IS REQUIRED FOR ANY WORK WITHIN THE EXISTING CITY RIGHT-OF-WAY
- 4. PRIOR TO THE START OF WORK, THE CONTRACTOR SHALL ARRANGE FOR A PRE-CONSTRUCTION MEETING WITH THE CITY, THE DESIGN ENGINEER, SOILS ENGINEER, UTILITIES AND OTHER REQUIRED INDIVIDUALS OR PUBLIC AGENCIES. CONTACT CITY CONSTRUCTION MANAGEMENT DEPARTMENT AT (925) 372-3596 AT LEAST TWO WORKING DAYS PRIOR TO THE START OF WORK.
- 5. ALL CONSTRUCTION AND GRADING OPERATIONS SHALL BE LIMITED TO WEEKDAYS (MONDAY THROUGH FRIDAY), 8:00 A.M. TO 5:00 P.M.
- 6. THE CONTRACTOR SHALL MAINTAIN ACCESS TO ALL PROPERTY ADJACENT TO THE WORK THROUGHOUT THE PERIOD OF CONSTRUCTION.
- 7. THE CONTRACTOR SHALL VERIFY THE EXACT LOCATION OF EXISTING UTILITIES AND SHALL NOTIFY UNDERGROUND SERVICE ALERT AT (800) 642-2600 TWO WORKING DAYS PRIOR TO COMMENCEMENT OF ANY EXCAVATION.
- 8. UTILITIES SHOWN ON THE PLANS ARE FOR INFORMATION ONLY AND BASED UPON AVAILABLE DATA. ANY UTILITIES EXPOSED OR DAMAGED BY THE CONTRACTOR SHALL BE REPAIRED BY HIM AT HIS EXPENSE.
- 9. THE CONTRACTOR SHALL POST EMERGENCY PHONE NUMBERS FOR THE CITY PUBLIC SERVICES AND POLICE DEPARTMENTS AND THE CONTRA COSTA COUNTY CONSOLIDATED FIRE DISTRICT.
- 10. THE CONTRACTOR ASSUMES SOLE AND COMPLETE RESPONSIBILITY FOR THE JOB SITE CONDITIONS AT ALL TIMES. THE CONTRACTOR SHALL PROVIDE ADEQUATE LIABILITY INSURANCE TO DEFEND, INDEMNIFY AND HOLD HARMLESS THE CITY OF MARTINEZ AND ITS EMPLOYEES FROM ANY CLAIMS OR DAMAGES THAT MAY ARISE FROM THIS CONSTRUCTION.
- 11. THE CONTRACTOR IS RESPONSIBLE FOR ARRANGING FOR ALL REQUIRED INSPECTIONS. THE PRESENCE OR ABSENCE OF A CITY OR OTHER INSPECTOR WILL NOT RELIEVE THE CONTRACTOR OF FULL RESPONSIBILITY FOR THE PROPER PERFORMANCE OF WORK.
- 12. ANY CONFLICTS WITH THE DESIGN OR ANY CHANGES TO THE PLANS SHALL BE SUBMITTED TO THE DESIGN ENGINEER AND AUTHORIZED BY THE CITY BEFORE CONTINUING WITH WORK IN THAT AREA. MAJOR CHANGES SHALL REQUIRE A PLAN REVISION AND MINOR CHANGES SHALL REQUIRE A PLAN CHANGE AUTHORIZATION FROM THE CITY.
- 13. THE CONTRACTOR SHALL REMOVE AND DISPOSE OF ALL SURPLUS EXCAVATION MATERIALS AND DEBRIS FROM THE SITE AND SHALL MAINTAIN THE SITE IN A NEAT AND ORDERLY CONDITION.
- 14. ANY PUBLIC OR PRIVATE PROPERTY DAMAGED BY THE CONTRACTOR OR ANY SUB-CONTRACTOR SHALL BE RESTORED TO ITS ORIGINAL CONDITION AT THE CONTRACTOR'S EXPENSE. ALL PUBLIC IMPROVEMENTS FOR THE PROJECT THAT ARE DAMAGED OR DISPLACED SHALL BE REPAIRED OR REPLACED BY THE CONTRACTOR AT HIS EXPENSE PRIOR TO ACCEPTANCE BY THE CITY.
- 15. ALL UTILITIES THAT LIE WITHIN THE STREET RIGHT-OF-WAY, INCLUDING MAINS AND LATERALS, SHALL BE INSTALLED PRIOR TO FINAL STREET SUBGRADE PREPARATION. THE CITY CONSTRUCTION MANAGEMENT SECTION SHALL BE NOTIFIED IN WRITING BY THE OWNER, OR ACCEPTING AGENCY, OF EACH UTILITY INSTALLATION BENEATH THE AREA TO BE PAVED THAT THE INSTALLATION HAS SATISFACTORILY PASSED FINAL ACCEPTANCE TESTS PRIOR TO PAVING.
- 16. THE STREET STRUCTURAL SECTION SHALL BE DETERMINED BY THE TRAFFIC INDEX SPECIFIED BY THE CITY AND FROM "R" VALUE TESTS TAKEN BY THE SOILS ENGINEER AT CITY SPECIFIED LOCATIONS (500' MAXIMUM INTERVALS) AFTER STREETS ARE ROUGH GRADED. PRIOR TO COMPACTION TESTS AND PLACEMENT OF BASE ROCK, THE STREET SECTION AND SUBGRADE CONDITION SHALL BE FIRM, HARD AND UNYIELDING TO THE SATISFACTION OF THE CITY ENGINEER.
- 17. AN EROSION CONTROL PLAN SHALL BE SUBMITTED TO THE CITY ENGINEER FOR REVIEW AND APPROVAL BY SEPTEMBER 1. THE APPROVED PLAN SHALL BE IN EFFECT FROM OCTOBER 1 TO APRIL 15 IN ACCORDANCE WITH SECTION 15.04.165 OF THE MARTINEZ MUNICIPAL CODE AND THE APPLICABLE STANDARDS.
- 18. THE CITY ENGINEER AND DESIGN ENGINEER SHALL APPROVE ALL FORMS AND GRADES PRIOR TO ANY CONCRETE POUR. MINIMUM ONE WORKING DAY PRIOR NOTICE IS REQUIRED, AND NO CONCRETE SHALL BE PLACED WITHIN TWO HOURS OF SUNSET OR DURING INCLEMENT WEATHER.
- 19. SEWER LATERALS AND WATER SERVICES SHALL BE INSTALLED IN SEPARATE TRENCHES WITH 5' MINIMUM HORIZONTAL SPACING.
- 20. ALL UTILITY TRENCHES SHALL BE BACKFILLED AT 95% RELATIVE COMPACTION PER CITY STANDARD DRAWING S-11.
- 21. STREET LIGHTS SHALL BE ENERGIZED AND ALL TRAFFIC SIGNS INCLUDING "NO PARKING" SIGNS SHALL BE INSTALLED PRIOR TO ISSUANCE OF FIRST OCCUPANCY PERMITS.
- 22. THE CONTRACTOR IS RESPONSIBLE FOR MATCHING EXISTING STREETS, SURROUNDING LANDSCAPE AND OTHER IMPROVEMENTS WITH A SMOOTH TRANSITION. PAVING CONFORMS SHALL BE MADE WITH A SMOOTHLY TRIMMED BUTT JOINT WITHOUT OVERLAPPING EXISTING PAVEMENT.
- 23. THE CONCRETE CONTRACTOR SHALL VERIFY LOCATIONS OF ALL DRIVEWAYS, SEWER AND WATER LATERALS BEFORE POURING THE CURB. A STAMPED "S" AND "W" SHALL BE MARKED ON THE CURB FOR LATERAL LOCATIONS AFTER CONCRETE IS POURED.
- 24. THE CITY SHALL BE PROVIDED WITH "AS BUILT" DRAWINGS ON PHOTO MYLAR (4 MIL), INCLUDING ALL CHANGES TO THE PROJECT, PRIOR TO FINAL ACCEPTANCE AND RELEASE OF SECURITIES BY THE CITY.
- 25. PROTECTION OF STREET MONUMENTS AND ROADWAY MARKERS: THE CONTRACTOR SHALL NOT DESTROY, REMOVE, OR OTHERWISE DISTURB ANY EXISTING SURVEY MONUMENT, SURVEY MARKERS, OR OTHER EXISTING STREET OR ROADWAY MARKERS WITHOUT PROPER AUTHORIZATION FROM THE CITY. NO PAVEMENT EXCAVATION SHALL START UNTIL ALL SURVEY MONUMENT OR OTHER PERMANENT MARKER POINTS THAT WILL BE DISTURBED BY THE CONSTRUCTION OPERATIONS HAVE BEEN IDENTIFIED AND PROPERLY REFERENCED FOR EASY AND ACCURATE RESTORATION. ALL SURVEY MONUMENTS, SURVEY MARKERS OR POINTS DISTURBED BY THE CONTRACTOR SHALL BE ACCURATELY RESTORED AT THE CONTRACTOR'S EXPENSE AFTER ALL STREET OR ROADWAY WORK IS COMPLETE. SURVEY MONUMENTS SHALL BE REESTABLISHED BY A REGISTERED LAND SURVEYOR OR REGISTERED CIVIL ENGINEER IN ACCORDANCE WITH STATE LAW.
- 26. THE APPLICABLE STANDARD DETAILS INCLUDE BUT ARE NOT LIMITED TO: (LIST APPLICABLE DETAILS)

GRADING NOTES

- 1. GRADING OPERATIONS SHALL BE CONDUCTED IN ACCORDANCE WITH APPENDIX "J" OF THE UNIFORM BUILDING CODE AS AMENDED BY SECTION 15.04.150 OF THE MARTINEZ MUNICIPAL CODE, THESE PLANS, THE RECOMMENDATIONS CONTAINED IN THE PROJECT SOILS REPORT, AND BY THE CITY'S CONSULTANT SOILS ENGINEER.
- 2. THE PROJECT SOILS ENGINEER AND/OR THE DESIGN ENGINEER WILL BE RESPONSIBLE FOR ON-SITE INSPECTION AND QUALITY CONTROL OF GRADING OPERATIONS. ALL REVISIONS MUST BE APPROVED IN WRITING PRIOR TO CONSTRUCTION BY THE PROJECT SOILS ENGINEER AND THE CITY ENGINEER PRIOR TO CONTINUING WITH WORK IN THAT AREA.
- 3. THE CONTRACTOR SHALL OBTAIN A GRADING AND/OR SITE DEVELOPMENT PERMIT FROM THE CITY. CONTACT PUBLIC WORKS DEPARTMENT AT (925) 372-3596 AT LEAST TWO WORKING DAYS PRIOR TO COMMENCEMENT OF WORK.
- 4. ALL GRADING WORK SHALL REQUIRE CERTIFICATION BY THE PROJECT SOILS ENGINEER AND DESIGN ENGINEER TO ENSURE THAT ELEVATIONS, OFFSETS, EARTHWORK, AND SOILS COMPACTION ARE DONE IN ACCORDANCE WITH THE PLANS AND THE SOILS REPORT. THE PAD AREA SHALL NOT VARY FROM THE DESIGN ELEVATION BY MORE THAN 0.1 FOOT AT ANY SPOT.
- 5. THE CONTRACTOR SHALL PROTECT ADJACENT PROPERTIES IN A MANNER THAT WILL PREVENT SLOUGHING OR ANY ENCROACHMENT. THIS MAY REQUIRE FENCING AND/OR BARRIERS TO BE PROVIDED. GRADING ON ADJACENT PROPERTIES WILL REQUIRE WRITTEN AUTHORIZATION FROM THE PROPERTY OWNER WITH A COPY FURNISHED TO THE CITY PRIOR TO COMMENCING SUCH WORK.
- 6. THE CONTRACTOR SHALL CONTROL THE DUST RESULTING FROM HIS OPERATIONS THROUGH WATERING OR OTHER SUITABLE METHODS ON THE SITE AND HAUL ROUTES.

WATER & SEWER NOTES

- 1. THE CONTRACTOR SHALL NOTIFY THE APPROPRIATE WATER DISTRICT OF ANY WORK IN THE VICINITY OF EXISTING WATER MAINS, AND OBTAIN SPECIFIC APPROVAL TO PROCEED. EXTREME CARE MUST BE TAKEN NOT TO DISRUPT WATER SERVICE. WORK ON WATER MAINS MUST BE DONE UNDER DISTRICT SUPERVISION WITH THE NECESSARY PERMITS. ALL WORK SHALL BE DESIGNED AND INSTALLED PER THE STANDARDS AND SPECIFICATIONS OF THE APPROPRIATE WATER DISTRICT.
- 2. SANITARY SEWER MATERIALS AND METHODS OF CONSTRUCTION SHALL CONFORM TO THE STANDARDS, SPECIFICATIONS AND DETAIL DRAWINGS OF THE APPROPRIATE SANITARY DISTRICT. THE CONTRACTOR SHALL OBTAIN A SEWER CONSTRUCTION PERMIT FROM THE DISTRICT OFFICE PRIOR TO COMMENCING WORK.
- 3. THE CONTRACTOR SHALL NOTIFY THE APPROPRIATE SANITARY DISTRICT OFFICE TWO WORKING DAYS PRIOR TO REQUIRING INSPECTION SERVICES.
- 4. FIRE HYDRANTS AND LOCATIONS THEREOF SHALL BE SHOWN ON THE PLANS AND APPROVED BY THE CONTRA COSTA COUNTY CONSOLIDATED

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SHEET INDEX

TITLE SHEET

PRECISE GRADING & DRAINAGE PLAN

SECTIONS & DETAILS

EROSION & SEDIMENT CONTROL PLAN

EROSION & SEDIMENT CONTROL DETAILS

C-5

<u>OWNER</u>

JOEL DIAZ
ADDRESS: 140 GLENDORA DR, MARTINEZ, CA 94553
PHONE: 707-333-4094
EMAIL: Diazjoel@live.com

ARCHITECTURAL DESIGNER

NAME: LEI ZHENG PHONE: (510) 909-1933 EMAIL: engineer.lei@gmail.com

CIVIL ENGINEER

NAME: LEI ZHENG PHONE: (510) 909-1933 EMAIL: engineer.lei@gmail.com

SURVEYOR


SUMMIT ENGINEERING ADDRESS: 5855 CASTLE DRIVE OAKLAND, CA 94611 PHONE: (510) 842-8064 FAX: (510) 482-5848

BASIS OF BEARING

THE BEARING OF THE LINE BETWEEN THE 1" IRON PIPE AND $\frac{5}{8}$ " IRON PIPE, WITH TAG LS 7893, RECORD OF SURVEY 3694, FOUND ON SERRANO STREET, IS TAKEN AS S 07° 20' 00" E, AS SHOWN.

BASIS OF ELEVATIONS:

THE ELEVATION 161.00 WAS USED AS A TEMPORARY BENCH MARK FOR THIS SURVEY, AS SHOWN

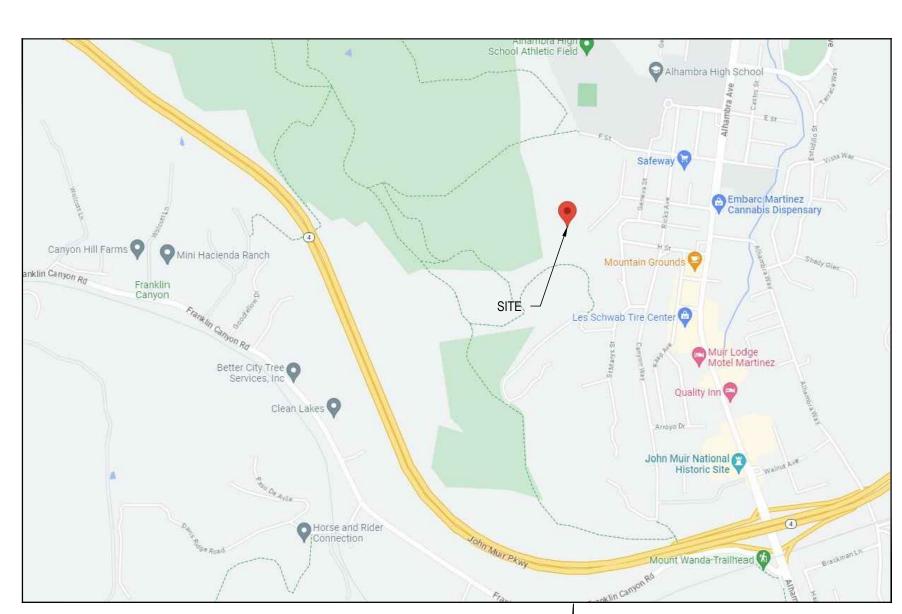





WWW.CECILIA123.COM
CHIEF ENGINEER:LEI ZHENG (MASON)
PHONE: (510)909-1933
EMAIL: ENGINEER.LEI@GMAIL.COM

DURING CONSTRUCTION IF ANY DIFFICULTY OCCUR, PLEASE CONTACT ENGINEER IMMEDIATELY .IF CONTRACTOR DEVIATE FROM THE DRAWING WITHOUT PRIOR APPROVAL FROM ENGINEER, THE CONTRACTOR WILL TAKE ALL THE LIABILITY DUE TO DEVIATION.

40 Glendora Dr, Martinez, CA 94553

REV.	DESCRIPTION	DATE
0	APPLY FOR PERMITS	02-22-202

Jurisdiction:





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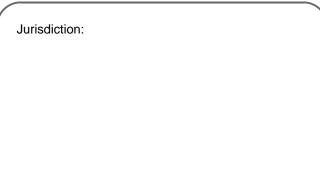
CHIEF ENGINEER:LEI ZHENG (MASON) PHONE: (510)909-1933 EMAIL: ENGINEER.LEI@GMAIL.COM

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DUE TO DEVIATION.

Martinez Glendo 40

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REV.	DESCRIPTION	DATE
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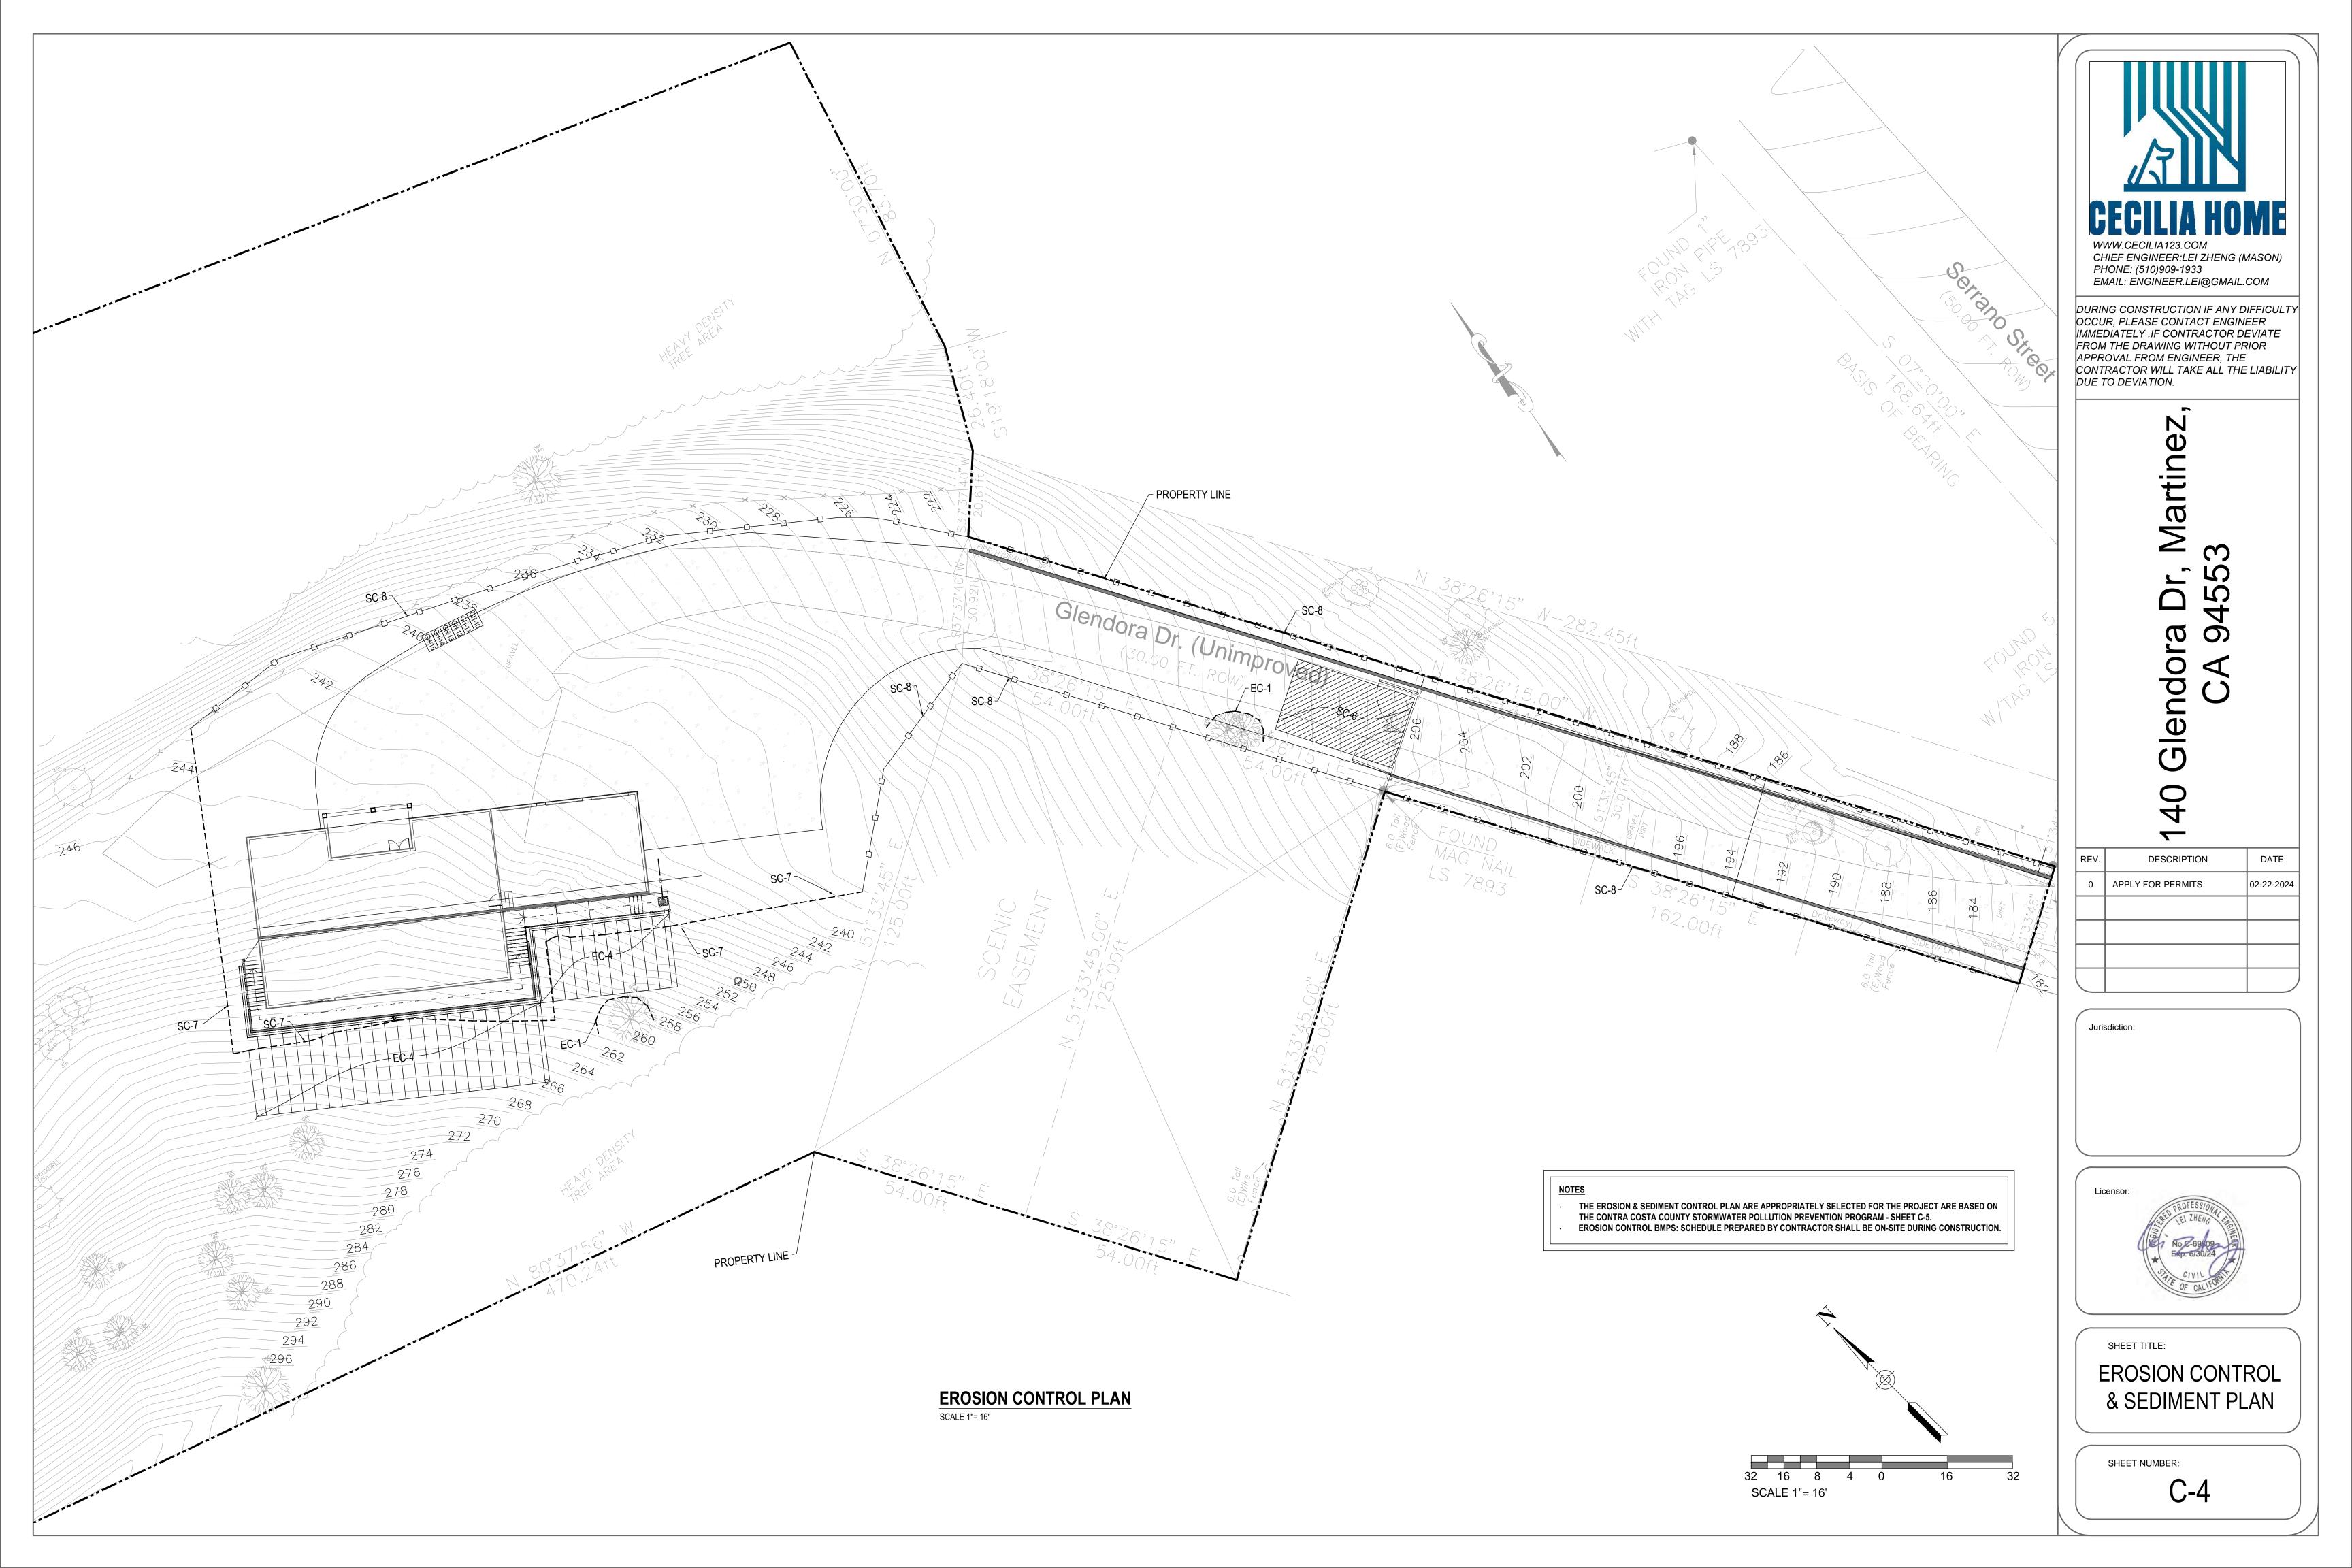


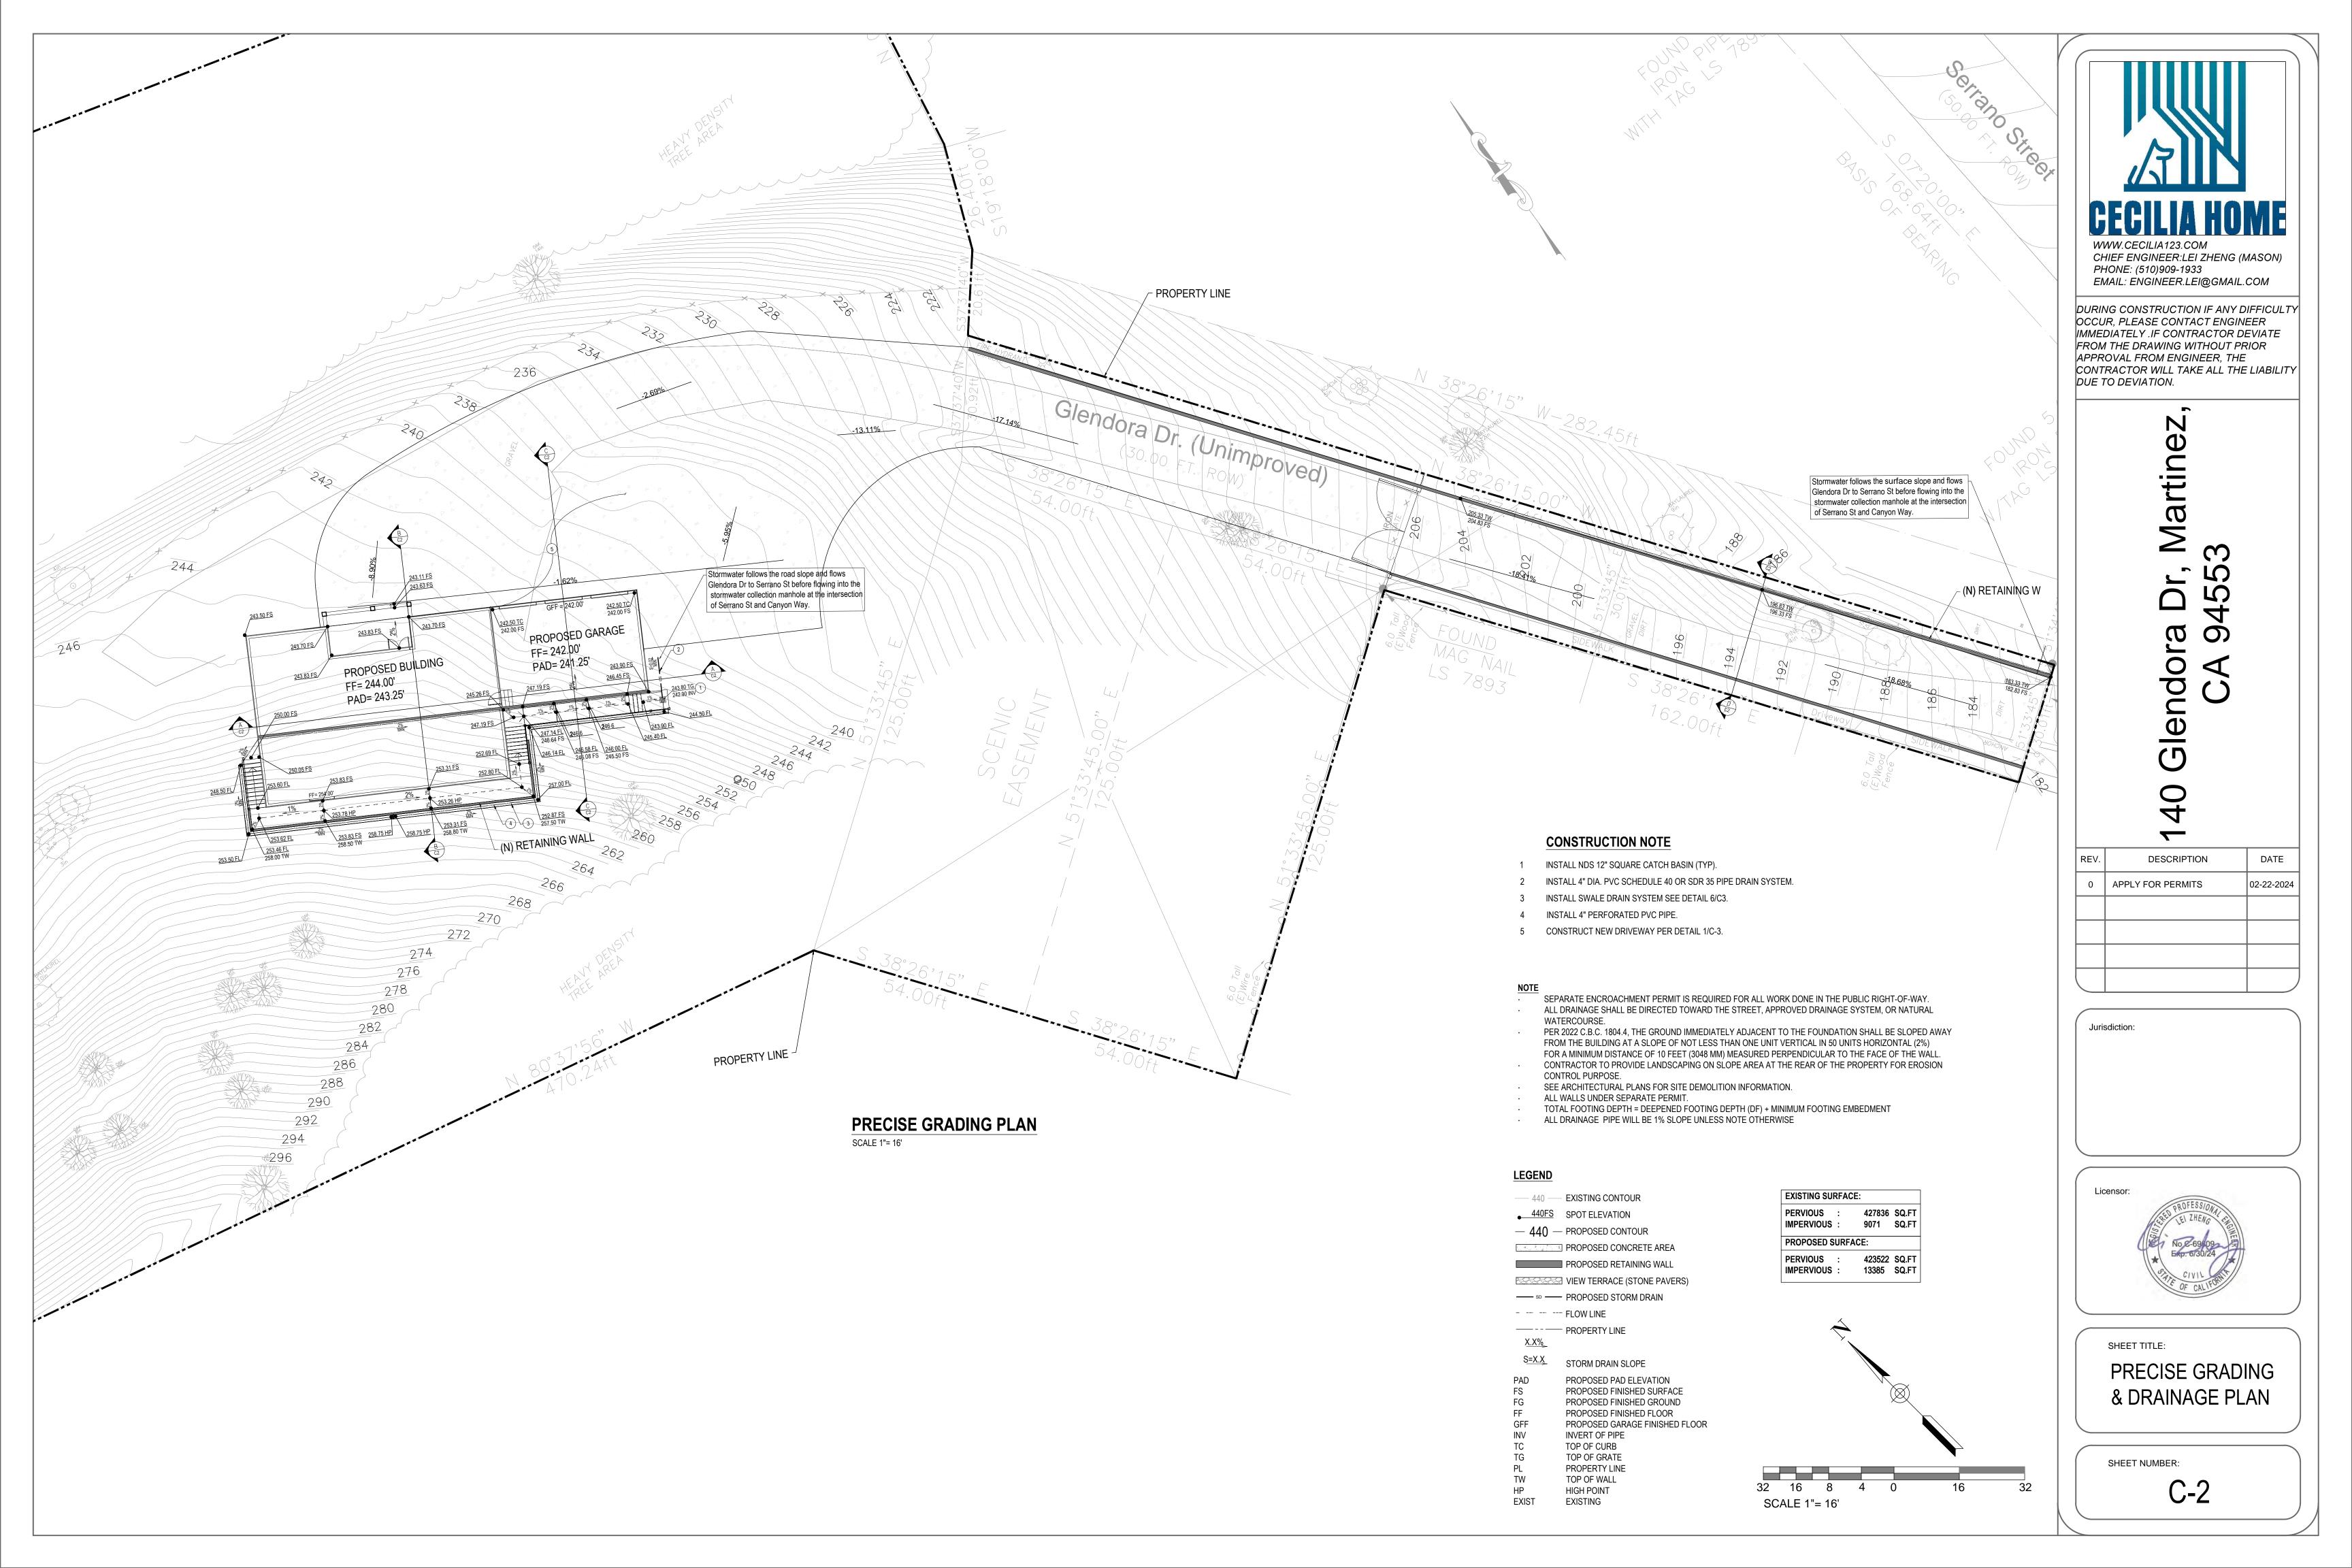SHEET TITLE:

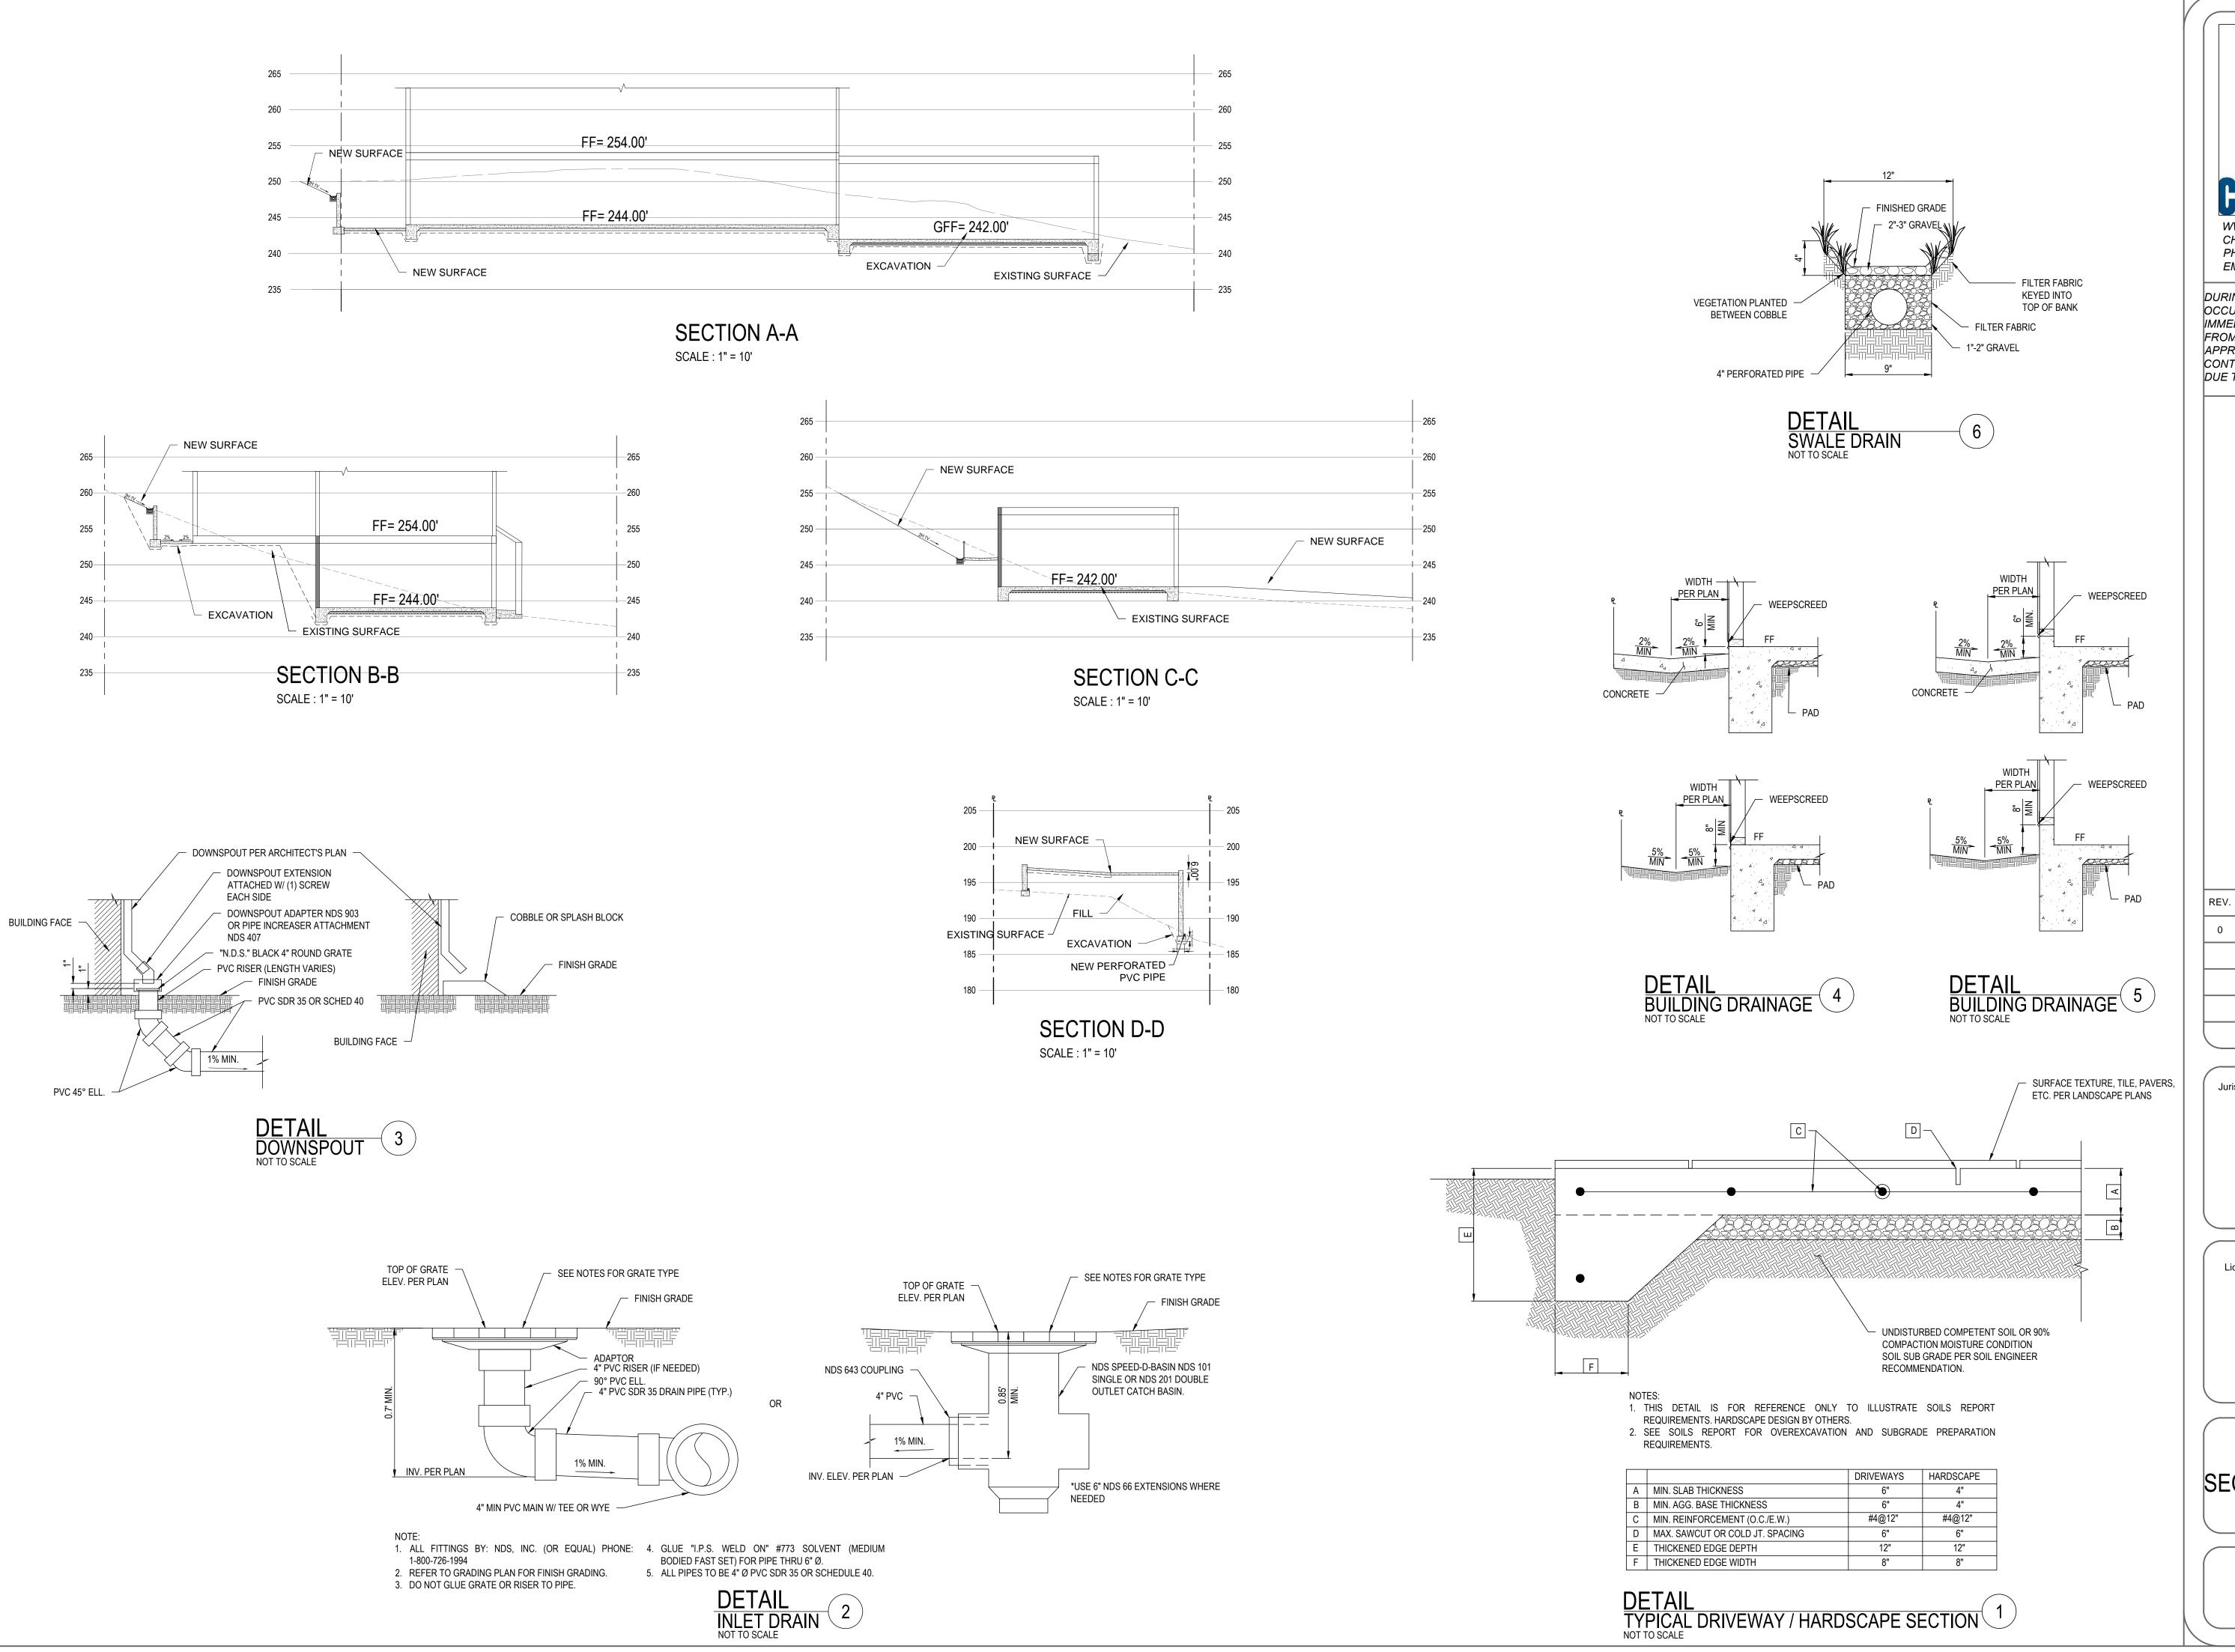SECTIONS AND DETAILS

SHEET NUMBER:

C-3



CONTRA COSTA COUNTY STORMWATER POLLUTION PREVENTION PROGRAM Minimum Control Measures For Small Construction Projects Department of Conservation and Development, 30 Muir Rd. Martinez, CA 94553 (925) 674-7200

Erosion Controls	Sediment Controls	Good Housekeeping
NS Scheduling	6. Tracking Controls	10. Concrete Washout
1. Preserve Vegetation & Creek Set Backs	7. Fiber Rolls	11. Stockpile Management
2. Soil Cover	8. Silt Fence	12. Hazardous Material Management
3. Soil Preparation/ Roughening	9. Drain Inlet Protection	13. Sanitary Waste Management
4. Erosion Control Blankets	NS Trench Dewatering	14. Equipment and Vehicle Maintenance
5. Revegetation		15. Litter and Waste Management


NS=not shown on graphic

Note: Select an effective combination of control measures from each category, Erosion Control, Sediment Control, and Good Housekeeping. Control measures shall be continually implemented and maintained throughout the project until activities are complete, disturbed areas are stabilized with permanent erosion controls, and the local agency has signed off on permits that may have been required for the project. Inspect and maintain the control measures before and after rain events, and as required by the local agency or state permit.

and as required by the local agency or state permit.

More detailed information on the BMPs can be found in the related California Stormwater Quality Association (CASQA) and California Department of Transportation (Caltrans) BMP Factsheets. CASQA factsheets are available by subscription in the California Best Management Practices Handbook Portal: Construction at http://www.casqa.org. Caltrans factsheets are available in the Construction Site BMP Manual May2017 at http://www.dot.ca.gov/hq/construc/stormwater/CSBMP-May-2017-Final.pdf.

_		General Description
		anagement Practices
N/A	Scheduling	Plan the project and develop a schedule showing each phase of construction. Schedule construction activitoreduce erosion potential, such as scheduling ground disturbing activities during the summer and phasing projects to minimize the amount of area disturbed. For more info see the following factsheets: CASQA: EC or Caltrans: SS-1.
EC-1	Existing Vegetation and Creek Setbacks	Preserve existing vegetation to the extent possible, especially along creek buffers. Show creek buffers on maps and identify areas to be preserved in the field with temporary fencing. Check with the local Planning Public Works Departments for specific creek set back requirements. For more info see the following factsheets: CASQA: EC-2; or Caltrans: SS-2.
	Soil Cover	Cover exposed soil with straw mulch and tackifier (or equivalent). For more info see the following factsheet CASQA: EC-3, EC-5, EC-6, EC-7, EC-8, EC-14, EC-16; or Caltrans: SS-2, SS-4, SS-5, SS-6, SS-7, SS-8.
EC-3	Soil Preparation/ Roughening	Soil preparation is essential to vegetation establishment and BMP installation. It includes soil testing and amendments to promote vegetation growth as well as roughening surface soils by mechanical methods (decompacting, scarifying, stair stepping, etc.). For more info see the following factsheets: CASQA: EC-15
EC-4	Erosion Control Blankets	Install erosion control blankets (or equivalent) on disturbed sites with 3:1 slopes or steeper. Use wildlife-friendly blankets made of biodegradable natural materials. Avoid using blankets made with plastic netting of fixed aperture netting. See: http://www.coastal.ca.gov/nps/Wildlife-Friendly_Products.pdf. For more info see the following factsheets: CASQA: EC-7; or Caltrans: SS-7.
	Revegetation	Re-vegetate areas of disturbed soil or vegetation as soon as practical. For more info see the following factsheets: CASQA: EC-4; or Caltrans: SS-4.
		Management Practices
SC-6	Tracking Controls	Stabilize site entrance to prevent tracking soil offsite. Inspect streets daily and sweep street as needed. Require vehicles and workers to use stabilized entrance. Place crushed rock 12-inches deep over a geotextile, using angular rock between 4 and 6-in. Make the entrance as long as can be accommodated or the site, ideally long enough for 2 revolutions of the maximum tire size (16-20 feet long for most light trucks Make the entrance wide enough to accommodate the largest vehicle that will access the site, ideally 10 feet wide with sufficient radii for turning in and out of the site. Rumble pads or rumble racks can be used in lieu or in conjunction with rock entrances. Wheel washes may be needed where space is limited or where the sentrance and sweeping is not effective. For more info see the following factsheets: CASQA: TC-1; TC-3; of Caltrans: TC-1; TC-3.
SC-7	Fiber Rolls	Use fiber rolls as a perimeter control measure, along contours of slopes, and around soil stockpiles. On slopes space rolls 10 to 20 feet apart (using closer spacing on steeper slopes). Install parallel to contour. I more than one roll is used in a row overlap roll do not abut. J-hook end of roll upslope. Install rolls per either Type 1 (stake rolls into shallow trenches) or Type 2 (stake in front and behind roll and lash with rope). Use wildlife-friendly fiber rolls made of biodegradable natural materials. Avoid using fiber rolls made with plastic netting or fixed aperture netting. See: http://www.coastal.ca.gov/nps/Wildlife-Friendly_Products.pdf. Manufactured linear sediment control or compost socks can be used in lieu of fiber rolls. For more info see the following factsheets: CASQA: SE-5 (Type 1); SE-12, SE-13; or Caltrans: SC-5 (Type and Type 2).
SC-8	Silt Fence	Use silt fence as a perimeter control measure, and around soil stockpiles. Install silt fence along contours. Key silt fence into the soil and stake. Do not use silt fence for concentrated water flows. Install fence at lea feet back from the slope to allow for sediment storage. Wire backed fence can be used for extra strength. Avoid installing silt fence on slopes because they are hard to maintain. Manufactured linear sediment cont can be used in lieu of silt fences. For more info see the following factsheets: CASQA: SE-1; SE-12; or Caltrans: SC-1.
SC-9	Drain Inlet Protection	Use gravel bags, (or similar product) around drain inlets located both onsite and in gutter as a last line of defense. Bags should be made of a woven fabric resistant to photo-degradation filled with 0.5-1-in washed crushed rock. Do not use sand bags or silt fence fabric for drain inlet protection. For more info see the following factsheets: CASQA: SE-10; or. Caltrans: SC-10.
N/A	Trench Dewatering	Follow MCSTOPPP BMPs for trench dewatering. http://www.marincounty.org/depts/pw/divisions/mcstoppp development/~/media/Files/Departments/PW/mcstoppp/development/TrenchingSWReqMCSTOPPPFinal69.pdf. For more info see the following factsheets: CASQA: NS-2; or Caltrans: NS-2.
Good	Housekeeping Be	st Management Practices
GH-10	Concrete Washout	Construct a lined concrete washout site away from storm drains, waterbodies, or other drainages. Ideally, place adjacent to stabilized entrance. Clean as needed and remove at end of project. For more info see the following factsheets: CASQA: WM-8; or .Caltrans: WM-8.
GH-11	Stockpile Management	Cover all stockpiles and landscape material and berm properly with fiber rolls or sand bags. Keep behind t site perimeter control and away from waterbodies. For more info see the following factsheets: CASQA: WI or Caltrans: WM-3.
GH-12	Hazardous Material Management	Hazardous materials must be kept in closed containers that are covered and within secondary containmen do not place containers directly on soil. For more info see the following factsheets: CASQA: WM-6; or Caltrans: WM-6.
GH-13	Sanitary Waste Management	Place portable toilets near stabilized site entrance, behind the curb and away from gutters, storm drain inlead waterbodies. Tie or stake portable toilets to prevent tipping and equip units with overflow pan/tray (movendors provide these). For more info see the following factsheets: CASQA: WM-9; or Caltrans: WM-9.
GH-14	Equipment and Vehicle Maintenance	Prevent equipment fluid leaks onto ground by placing drip pans or plastic tarps under equipment. Immedia clean up any spills or drips. For more info see the following factsheets: CASQA: NS-8, NS-9, and NS-10; Caltrans: NS-8, NS-9, and NS-10.
GH-15	Litter and Waste Management	Designate waste collection areas on site. Use watertight dumpsters and trash cans; inspect for leaks. Covat the end of each work day and when it is raining or windy. Arrange for regular waste collection. Pick up solitter daily. For more info see the following factsheets: CASQA: WM-5; or Caltrans: WM-5.

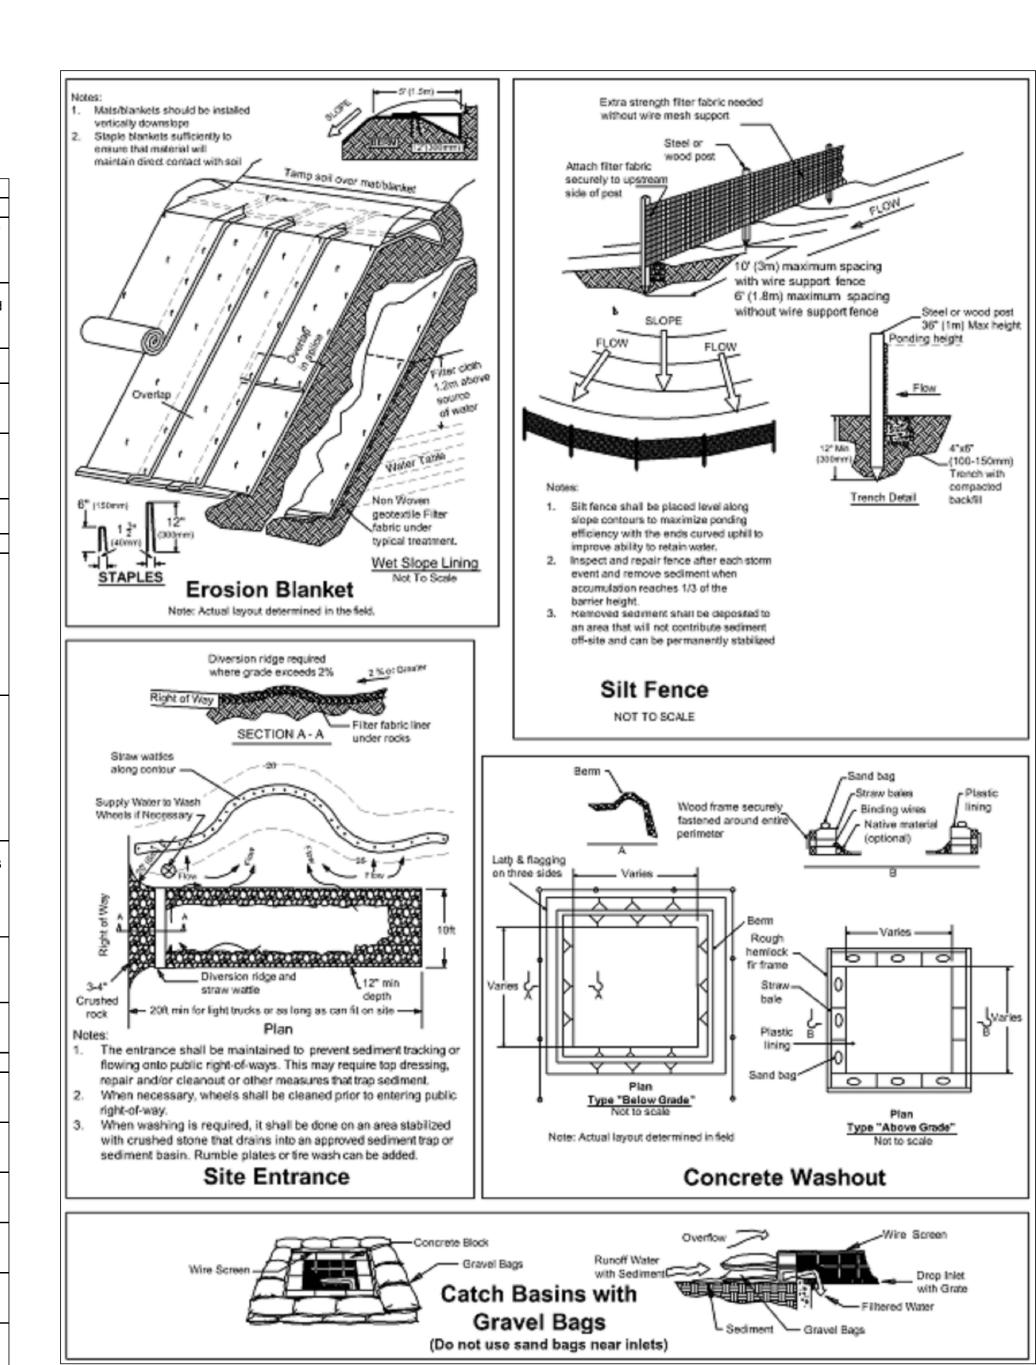



PHONE: (510)909-1933

EMAIL: ENGINEER.LEI@GMAIL.COM


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140 Glendora Dr, Martinez, CA 94553

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REV.	DESCRIPTION	DATE
0	APPLY FOR PERMITS	02-22-2024

Jurisdiction:



SHEET TITLE:

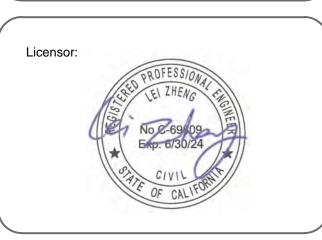& SEDIMENT DETAILS

SHEET NUMBER:

C-5



STAFF REPORT

Planning Commission

Date: June 25, 2024

To: Planning Commission

From: Michael P. Cass, Planning Manager

Prepared By: Michael P. Cass, Planning Manager

Subject: Growth Management Element Update

Recommendation

Conduct a public hearing and adopt Planning Commission Resolution No. 24-05, forwarding a recommendation to the City Council to approve amendments to the Growth Management Element of the General Plan.

Background

In 1988, Contra Costa County voters approved Measure C, which established a countywide half-cent transportation sales tax for 20 years (through 2008). Measure C also established a countywide Growth Management Program("GMP") to plan for and accommodate increases in population, households, traffic, and jobs during that timeframe. In 2004, County voters approved Measure J, which extends the half-cent transportation sales tax and GMP for an additional 25 years, through 2034. In addition to raising local funds for transportation-related projects and programs, Measure J also requires all jurisdictions within the County to adopt an Urban Limit Line and to modify their Growth Management Elements of their General Plans to incorporate additional Measure J provisions regarding multi-modal goals, policies, and actions. To comply with this provision, the City adopted the voter-approved Urban Limit Line in May 2007.

To ensure that agencies are complying with the requirements established by Measure J, the Contra Costa Transportation Authority ("CCTA") requires each agency to complete and submit a Measure J Compliance Checklist every two years before its share of Measure J "Return to Source" Maintenance Funds are released.

Discussion

The General Plan 2035 was created through the contributions of decision makers, the General Plan Update Task Force, individual residents, and representatives of many organizations in the community. The update process began with the preparation of the General Plan Work Program in 2010 and ended with City Council adoption in November

2022 and minor amendments on December 20, 2023. However, the Growth Management Element of the General Plan was not updated as part of the comprehensive update.

The proposed amendments are based upon CCT's Model Element and the adopted General Plan 2035. Notable changes include the following:

- Adding reference to the existing half-cent transactions and use tax
- Adding the requirement for a Transportation Impact Report/Traffic Impact Study for any project estimated to generate more than 100 net new peak-hour regional trips, pursuant to Measure J
- Adding a definition for Regional Transportation Planning Committee
- Referencing the Routes of Regional Significance
- Expanding the definition of Action Plan
- Modifying the goals, policies, and implementation measures for consistency with the General Plan 2035

Prior to adoption of the General Plan Amendment, the City shall make the finding that the proposed amendment is consistent with the existing General Plan 2035. The proposed General Plan Amendment is intended to incorporate revised language, goals, policies, and implementation measures so the Growth Management Element complies with the requirements of the Measure J GMP. Specifically, the proposed General Plan Amendment is consistent with the following goals and policies:

- GOAL LU-G-8: Encourage the preservation of existing agricultural businesses and minimize and resolve conflicts between agricultural and urban uses within and adjacent to the Alhambra Valley semi-rural residential community.
- Policy LU-P-12.2: Focus infill development on the east and west edges of the Downtown including the Downtown Core, Downtown Government and Downtown Shoreline areas, utilizing the County offices and the Amtrak Station as anchors that support fine- grained rehabilitation and small retail and restaurant business attraction, on the central shopping streets in between.
- Policy C-P-2.1: Achieve and maintain an intersection level-of-service (LOS) D or better during peak hours where possible. Recognizing that LOS D may not be feasibly achieved or maintained upon full buildout of the Land Use Element due to neighborhood context, multi-modal access considerations, impacts to existing uses, and/or regional factors outside the control of the City, the City Council shall maintain discretion to require mitigation measures that will reduce impacts but may not achieve target LOS when considering new development projects.
- Measure C-I-2.1i: Require proposed developments meeting trip generation thresholds to study the LOS impacts of the development and provide appropriate improvements to lessen their impacts. Engineering Department to approve study

methodology. Require proposed developments meeting CEQA thresholds to provide appropriate mitigation measures to lessen their VMT. VMT study methodology should follow the CCTA Implementation Guide and VMT limits.

The Planning Commission is now being asked to adopt the Resolution (Attachment A) forwarding a recommendation to the City Council to approve amendments to the Growth Management Element of the General Plan (Exhibit A).

Noticing Requirements/Public Outreach

In compliance with Martinez Municipal Code Section 22.40.040 and Government Code Section 65091, a public hearing notice was published in the *Contra Costa News Register*, was posted at City Hall; and was mailed via first class or electronic mail to individuals who had previously filed written request for such notice a minimum of 10 days in advance of the original public hearing date. No public comments were received at the time this staff report was prepared.

Fiscal Impact

The proposed amendment would have a positive fiscal impact as adoption of the revised Growth Management Element would allow the City to continue to collect and be eligible for Measure J funds. However, if the revised Growth Management Element is not adopted, then this could jeopardize the City continuing to receive and be eligible for Measure J funds. CCTA authorized an allocation of \$750,637 and \$688,620 for Fiscal Years 2021-22 and 2022-23 respectively.

Attachments

- Attachment A Planning Commission Resolution No. 24-05
- Exhibit A Draft Growth Management Element Update

RESOLUTION NO. 24-05

RESOLUTION OF THE PLANNING COMMISSION OF THE CITY OF MARTINEZ FORMWARDING A RECOMMENDATION TO THE CITY COUNCIL TO APPROVE AMENDMENTS TO THE GROWTH MANAGEMENT ELEMENT OF THE GENERAL PLAN

WHEREAS, the State of California requires that cities adopt a General Plan to guide their longterm physical growth and development and General Plans contain the goals and policies upon which city councils and planning commissions base their land use decisions; and

WHEREAS, the City of Martinez's General Plan was adopted in 1973, and several amendments have been incorporated since then, including the City's adoption of the General Plan Transportation Element in 1992, Housing Element Update in 2011, and Growth Management Element in 2013; and

WHEREAS, on November 2, 2022, the City Council adopted Resolution No. 170-22, approving the General Plan 2035; and

WHEREAS, on December 20, 2023, the City Council adopted Resolution No. 146-33, approving minor revisions to the elements, which are intended to provide the reader with additional clarification and therefore serve to assist the reader with understanding of the General Plan; and

WHEREAS, in 1988, Contra Costa County voters approved Measure C, which established a countywide half-cent transportation sales tax for 20 years (through 2008). Measure C also established a countywide Growth Management Program("GMP") to plan for and accommodate increases in population, households, traffic, and jobs during that timeframe; and

WHEREAS, in 2004, County voters approved Measure J, which extends the half-cent transportation sales tax and GMP for an additional 25 years, through 2034. In addition to raising local funds for transportation-related projects and programs, Measure J also requires all jurisdictions within the County to adopt an Urban Limit Line and to modify their Growth Management Elements of their General Plans to incorporate additional Measure J provisions regarding multi-modal goals, policies, and actions; and

WHEREAS, the City initiated amendments to the Growth Management Element of the General Plan for consistency with Measure J and the recently updated General Plan 2035, attached hereto as Exhibit A; and

WHEREAS, the Record of Proceedings ("Record") upon which the Planning Commission bases its consideration of the General Plan Update includes, but is not limited to: (1) all staff reports, City files and records and other documents prepared for and/or submitted to the Planning Commission, and the City relating to the General Plan Update; (2) the evidence, facts, findings, and other determinations set forth in this resolution; (3) all documentary and oral evidence received at public hearings or submitted to the City relating to the General Plan Update; and (4) all other matters of common knowledge to the Planning Commission including, but not limited to, City, state and federal laws, policies, rules, regulations, reports, records and projections related to the preparation and adoption of the General Plan Update; and

WHEREAS, on June 25, 2024, the Planning Commission held a duly noticed public hearing to consider forwarding a recommendation to the City Council to approve amendments to the Growth Management Element of the General Plan, at which time all interested parties had the opportunity to be heard; and

WHEREAS, proper notice of said hearing was given in all respects as required by law; and

WHEREAS, the Planning Commission did hear and consider all said reports, recommendations and testimony herein above set forth and used its independent judgement to evaluate the proposed actions.

NOW, THEREFORE, BE IT RESOLVED, that the Planning Commission of the City of Martinez hereby forwards a recommendation to the City Council to approve amendments to the Growth Management Element of the General Plan.

* * * * *

I HEREBY CERTIFY that the foregoing is a true and correct copy of a resolution duly adopted by the Planning Commission of the City of Martinez at a Regular Meeting of said Commission, held on the 25th day of June, 2024, by the following vote:

neid on the 25" day of June, 2024, by the followi	ng vote:
AYES:	
NOES:	
ABSTAIN:	
ABSENT:	
	Sean Trambley, Planning Commission Chai
ATTEST:	

Michael P. Cass, Planning Manager

GROWTH MANAGEMENT ELEMENT

11.1 | INTRODUCTION

Purpose

The purpose of the Growth Management Element is to establish goals, policies, and implementation measures that will be used to manage and mitigate the impacts of future growth and development within Martinez, especially as they relate to local, countywide, and regional transportation systems. By adopting and implementing an updated Growth Management Element, the City intends to establish a comprehensive, long-range program that will address the demands for multi-modal transportation facilities and services generated by new development through planning, capital improvement programs, and development mitigation programs.

This element has been prepared to comply with the requirements of the Measure J Growth Management Program ("GMP") as implemented by the Contra Costa Transportation Authority ("CCTA") and to establish performance standards to address the effect of new development on public services.

The Growth Management Element is an optional element of the General Plan under California Government Code Section 65303 which states: "The general plan may include any other elements or address any other subject which, in the judgment of the legislative body, relate to the physical development of the county or city." Growth Management Elements are adopted to manage and mitigate the impacts of future growth within a jurisdiction. When integrated with the policies of the Land Use and Circulation Elements, the policies of the Growth Management Element are intended to avoid or reduce the negative impacts "new growth" could otherwise have on existing public services, such as further congesting roadways and/or reducing services.

Background

Contra Costa County Measures C and J

Within Contra Costa County, local jurisdictions are required to adopt a Growth Management Element to comply with the requirements of voter-approved transportation sales tax and growth control Measures C (1988) and J (2004). Both programs include a ½ percent transportation and retail transactions and use tax intended to address existing major regional transportation problems. This Growth Management Element updates the 2013 Growth Management Element, which updated the City's 1992 Growth Management Element that was adopted as a requirement of Measure C. Measure C and J established the CCTA and its GMP; the GMP was then revised and extended by Measure J.

This Growth Management Element update was prepared to respond to Measure J and substantially comply with the intent of the CCTA model Growth Management Element, dated

GROWTH MANAGEMENT ELEMENT

December 2021. Further, each jurisdiction must comply with the Countywide voter approved Urban Limit Line ("ULL") to be in compliance with Measure J's GMP.

Growth Management Program Requirements

The GMP requires each local jurisdiction within Contra Costa County to:

- Adopt a Growth Management Element;
- Adopt a Development Mitigation Program;
- Participate in an ongoing, cooperative multi-jurisdictional planning process, including implementation of Action Plans adopted by CCTA;
- Require a Transportation Impact Report/Traffic Impact Study for any project estimated to generate more than 100 net new peak-hour regional trips;
- Address housing options and job opportunities;
- Develop a five-year Capital Improvement Program; and
- Adopt a Transportation Demand Management ("TDM") or Transportation Systems Management ("TSM") ordinance or resolution.

CCTA Funding

In addition to requiring the initial adoption of a Growth Management Element, CCTA's GMP requires periodic reporting from Contra Costa cities and the County to assure the GMP is being followed. Submission and approval of the cities "Growth Management Compliance Checklist" allows CCTA to return a portion of the half-cent sales tax to the participating City ("return-to-source"). Martinez has successfully participated in CCTA's requirements for return to source funding since the Measure C programs were established. In 2004, the voters approved Measure J, which extended CCTA's sales tax and growth management programs to 2034.

Compliance with the GMP is linked to receipt of CCTA's Local Street Maintenance and Improvement Funds and Transportation for Liveable Community Funds.

Urban Limit Line

Measure J required the Growth Management Element to document the required ULL. The ULL that Countywide voters approved in November 2006 is included In the Land Use Element of this General Plan and is shown on Land Use Figure 2-1b.

The intent of Contra Costa County's ULL policy is to encourage sustainable infill development and preserve non-urban agricultural lands, open space, and environmental resources.

11.2 | REGULATORY FRAMEWORK AND DEFINITIONS

Contra Costa Transportation Authority. CCTA is a regional government agency created in 1988 to manage funds generated by the voter approved, half cent transportation sales tax, Measure

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C, and its extension, Measure J. CCTA oversees planning and construction of capital projects included in Measure C and J Expenditure Plans and implements the County's GMP. CCTA also serves as Contra Costa's Congestion Management Agency. Below are definitions of terms from CCTA for the Growth Management Element.

Urban Limit Line (ULL). A planning boundary, defined by voters, beyond which no urban uses can be designated during the term of the General Plan. Properties that are located outside the ULL may not obtain General Plan Amendments that would re-designate them for an urban land use. Land inside the ULL is governed by the land use designations contained in the General Plan. However, the fact that a property is located inside the ULL provides no guarantee or implication that it may be developed during the lifetime of the General Plan.

Regional Transportation Planning Committee (RTPC). Transportation Partnership and Cooperation ("TRANSPAC") is the RTPC for Central Contra Costa. It is composed of elected representatives, planning commissioners, and technical staff from the six central Contra Costa jurisdictions including the cities of Clayton, Concord, Martinez, Pleasant Hill, and Walnut Creek, and the unincorporated area of Central Contra Costa County. TRANSPAC is responsible for the development of transportation plans, projects and programs for the Central County areas as well as the appointment of two representatives to the CCTA who serve alternating two-year terms.

Routes of Regional Significance ("Regional Routes"). Regional Routes are designated by the CCTA based on recommendations from the respective RPTC and TRANSPAC. In evaluating the appropriateness of the designation, the following criteria are used: 1) connection of two or more "regions" of the County; 2) connection across County boundaries; 3) significant amount of through traffic; and 4) provision of access to a regional highway or transit facility. The Regional Routes designated in the 2017 Central County Action Plan are State Route 4, State Route 242, Interstate 680, Alhambra Avenue, Bailey Road, Clayton Road, Contra Costa Boulevard, Geary Road, North Main Street, Pacheco Boulevard, Pleasant Hill Road, Taylor Boulevard, Treat Boulevard, and Ygnacio Valley Road/Kirker Pass Road. Other roads may be proposed in the future for designation by CCTA.

Action Plan. A document prepared by CCTA through the respective RTPC. Action Plans address Routes of Regional Significance and are comprised of the following:

- Long-range assumptions regarding future land use based on local general plans;
- Overall policy goals established by CCTA;
- For each regional route or corridor, Multimodal Transportation Service Objectives ("MTSOs") that serve as quantifiable performance measures; and

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Actions to be implemented by the RTPC and participating local jurisdictions. These
actions include capital improvements, transit improvements, traffic operations
strategies, pedestrian and bicycle facilities, land use policies, TDM or TSM strategies, or
other local projects and programs intended to meet the adopted MTSOs.

Transportation Demand Management ("TDM") or Transportation Systems Management ("TSM"). A program to increase efficiency of the transportation systems, reduce demand for road capacity during peak hour and otherwise affect travel behavior(s) to minimize the need for capacity increasing capital projects. An adopted TDM or TSM program is a requirement for compliance with Measure J.

11.3 | GROWTH MANAGEMENT GOALS, POLICIES, AND IMPLEMENTATION MEASURES

GM-G-1 Manage the City's Growth, Support Infill Development and Redevelopment of Existing Urban and Brownfield Areas, and Protect Open Space by Establishing and Maintaining an ULL. Apply a voter approved ULL consistent with the requirements of the Measure J GMP, either as mutually voted on Countywide, or relating solely to Martinez. Note: The ULL can only be amended by a subsequent vote of the electorate; minor adjustments of less than 30 acres may be approved by the City Council as provided for by the Measure J GMP.

Policy GM-P-1: Maintain the Countywide voter approved ULL as adopted by City Council on May 2, 2007 (Resolution No. 029-07), subject to future City and/or Countywide modifications that are consistent with the requirements of the Measure J GMP, through March 31, 2034, and any subsequent extensions of Measure J.

Measure GM-I-1.1a: Review development projects and long-range plans to make certain that urban growth is located within the ULL.

Policy GM-P-1.2: Alhambra Valley is an established semi-rural community of approximately 1,000 acres, entirely located within the City of Martinez SOI, with portions annexed into the City in 2012. The 2007 ULL inadvertently created an "island" (approximately 17 properties, 115 acres) and a "peninsula" (one property, 10 acres) of such-rural residential areas outside of the designated urban areas of the ULL. These areas are currently outside City Limits, but are within the City of Martinez Water Service Area and several existing residences receive City water. While LAFCO's Water and Wastewater

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Services Municipal Services Review (2008) recommends that these areas be annexed to the City, Measure J's GMP requires that the CCTA withhold its "Return to Source Funds" from the City, should the City to make an application to LAFCO to annex any area outside the 2007 ULL. By either future City Council action(s) to individually amend the ULL, and/or through a future Countywide ULL update(s), these areas should be placed inside of the ULL so that the City may apply to annex these areas in a manner consistent with the GMP and thus retain CCTA funding. Such an annexation would be consistent with the intent of the GMP and ULL, as City will adopt the County's current General Plan and Zoning designations, assuring that new development cannot exceed the level currently permitted under County regulations.

Measure GM-I-1.2a: Support an amendment to the ULL to annex the remaining "island" and "peninsula" portions of Alhambra Valley.

GM-G-2 Provide adequate infrastructure and facilities, including new and improved pedestrian, bicycle, parking, and transit facilities, to meet future demands of new development and population growth.

Policy GM-P-2.1: Continue to require new development to pay its fair share of needed transportation Improvements through the City's adopted transportation impact/mitigation fee schedule, as amended, and through implementation of regional development mitigation fees or other mitigations In accordance with TRANSPAC adopted Sub-regional Transportation Mitigation Program ("STMP").

Measure GM-I-P-2.1a: Review and update the City's transportation impact fee schedule to ensure the fees are commensurate with the associated costs to construct and improve facilities and infrastructure, including participation in applicable regional programs.

Measure GM-P-2.1b: Evaluate and participate in a regional development mitigation program to establish fees, exactions, assessments, or other mitigation measures to fund regional or sub-regional transportation improvements needed to mitigate the impacts of planned or forecasted development on the regional transportation system and address MTSOs. This includes regular review of STMPs to ensure the project accounts for impacts of new development and current goals and objectives of the Action Plan. STMPs with a uniform fee program should review project lists and fee structures every four to six years while STMPs with other mitigation should base the review schedule on program components.

Measure GM-P-2.1c: Maintain the City's five-year Capital Improvement Program ("CIP") that describes City-sponsored capital projects, including projects that address the goals of

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this General Plan. During development of the five-year CIP, City staff will prepare a cost analysis, list of projects, and a financial plan to provide the improvements.

Policy GM-P-2.2: Approval of development projects shall be contingent on the project meeting the following conditions: 1) no revenue from Measure J has been used to replace or provide the developer funding for any mitigation project; 2) the development project will fully fund public facilities and infrastructure necessary for mitigating any impacts from the project; and 3) full payment of mitigation fees for facilities and improvements in proportion to the project impacts.

GM-G-3 Participate in on-going multi-jurisdictional transportation planning programs with other agencies, TRANSPAC, and CCTA, that enhance the County's land use and circulation system to create a balanced, safe, and efficient transportation system and to manage the impacts of growth.

Policy GM-P-3.1: Participate with TRANSPAC, CCTA, and local jurisdictions in developing and implementing Action Plans to address problems on Regional Routes, including Interstate 680, State Route 4, Alhambra Avenue, and Pacheco/Contra Costa Boulevard, and to address MTSOs

Measure GM-I-3.1a: Work with TRANSPAC local jurisdictions to develop and maintain an Action Plan that addresses Regional Routes, MTSOs, and actions for achieving MTSOs, establishes a process for addressing transportation impacts of proposed new development, and addresses goals and metrics in regard to safety, climate change, and equity.

Measure GM-I-3.1b: Participate in the preparation of the CCTA's Countywide Comprehensive Transportation Plan and the ongoing countywide transportation planning processes.

Measure GM-I-3.1c: Participate in CCTA's conflict resolution process as needed to resolve disputes related to the development and implementation of Action Plans and other programs described in this Element.

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Measure GM-I-3.1d4: Following the adoption of the Regional Route Action Plans by TRANSPAC and CCTA, implement specified local actions in a timely manner, consistent with adopted Action Plans.

Policy GM-P-3.2: For the purposes of reporting to CCTA on compliance with the Growth Management Program, bi-annually complete and submit to CCTA compliance checklist.

Policy GM-P-3.3: Require development projects to address transportation impacts and to demonstrate how the project furthers transportation network components that support public transit, pedestrian, and bicycle access and how the project addresses the City's priorities related to safety, climate change, and equity. Apply CCTA's travel demand forecasting model and Technical Procedures to the analysis of General Plan Amendments and developments exceeding specified thresholds to identify and address their effect on the regional transportation system, including the Action Plan MTSOs. The transportation impact report shall address all CCTA requirements, including evaluation of vehicle miles travelled ("VMT") and evaluation of impacts to each transportation mode using the metrics defined by the Action Plan and Technical Procedures. CCTA has set 100 net new peak hour trips as the threshold for requiring traffic impact reports. TRANSPAC has set a threshold of 500 net new peak hour trips as the threshold for requiring Regional Transportation Planning Committee review of a General Plan Amendment.

Measure GM-I-3.3a: Prior to project approval, require a transportation impact report for all General Plan Amendments and developments that meets the thresholds identified by Policy GM-P-3.3. The report shall:

- 1) apply CCTA's travel demand forecasting model and Technical Procedures to the impact analysis;
- 2) address all CCTA requirements, including evaluation of VMT and the proposal's effect on the regional transportation system, including the Action Plan and MTSOs; and
- 3) evaluate impacts to each transportation mode using the metrics defined by the Action Plan and Technical Procedures.

Measure GM-I-3.3b: Circulate traffic impact analyses to affected neighboring jurisdictions, TRANSPAC, and, when appropriate, to neighboring RTPCs for review and public comment.

Measure GM-I-3.3b: Assist in the maintenance of CCTA's travel demand modeling system by providing information on proposed land use development and transportation projects, including the five-year CIP, projects that the jurisdiction has adopted as part of its five-

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year CIP, and other long-range plans relative to the Association of Bay Area Government's projections for households and jobs within the City.

GM-G-4 Make reasonable progress in providing housing opportunities for all income levels and demonstrate to CCTA reasonable progress in meeting housing goals.

Policy GM-P-4.1: Demonstrate reasonable progress in addressing housing goals and providing housing opportunities for all income levels.

Measure GM-I-4.1a: Prepare an annual progress report on the implementation of the Housing Element for submittal to the California Department of Housing and Community Development and the Governor's Office of Planning and Research, as well as a biennial report for submittal to CCTA as part of the biennial GMP Compliance Checklist.

GM-G-5 Encourage land use and development policies to minimize the negative impacts on open space; the local, regional, and countywide transportation system, including the level of transportation capacity that can reasonably be provided, such as mixed use high density infill; support regional approaches to transportation and land use planning; and coordinate with adjacent jurisdictions to monitor growth and development.

Policy GM-P-5.1: Continue to participate in on-going regional transportation efforts to reduce cumulative traffic impacts and implement Action Plans.

Measure GM-I-5.1a: Continue to work with CCTA and surrounding jurisdictions to develop General Plans and Specific Plans that study and consider the effect of large-scale development on the regional transportation system.

Measure GM-I-5.1b: Pursue funding from the CCTA for roadway projects intended to maintain levels of service standards that implement the adopted Action Plan.

Measure GM-I-5.1c: Provide data to CCTA on planned, proposed, and approved development to assist in maintaining an accurate TDM system.

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Policy GM-P-5.2: Approve proposed development projects that generate more than 100 net new peak hour vehicle trips only if findings of consistency with adopted traffic levels of service standards can be made.

Policy GM-P-5.3: Implement the TDM regulations to address changes to the CCTA model TDM/TSM programs.

Measure GM-I-5.3a: Update the TDM regulations, as needed, to be consistent with the model TDM ordinance, adopted by CCTA, including promoting transit access, carpools, vanpools, and park and ride lots, and addressing MTSOs. Work to provide the required level of staffing for implementation of the TDM program.

Policy GM-P-5.4: If attainment of standards is not possible because of a high proportion of through-traffic, excessive cost, or unacceptable impacts to the environment, the City may prepare a request for Findings of Special Circumstances to remain in compliance with the Growth Management Program. It will be submitted to CCTA, consistent with the procedure prescribed by CCTA. The request shall identify alternative standards for the intersection, and propose mitigation measures and programs to improve service to the extent possible.

GM-6 Compliance with applicable levels of service

Policy GM-P-6.1: Require development projects to participate in the provision and expansion of essential community services and facilities, including parks and recreation, fire and police facilities, governmental and cultural facilities, water, wastewater, storm drainage, and other utilities and infrastructure, to make certain growth does not exceed the City's ability to provide services, does not reduce levels of service, and does not place an economic or environmental burden on existing residents.

Program GM-I-6.1a: Require new development to demonstrate that the City's existing or planned community services and facilities can accommodate the increased demand prior to or at completion of the project.

Program GM-I-6.1b: Require new development to offset or mitigate impacts to community services and facilities, including fair-share contribution of the costs of required public infrastructure and services, to ensure that service levels for existing users are not degraded or impaired.

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Policy GM-P-6.2: Adopt and maintain a development mitigation program to ensure new growth is paying its share of the costs associated with that growth.

Program GM-I-6.2b: Periodically review and update the City's development impact/mitigation fee schedules for parks and recreation, fire and police facilities, governmental and cultural facilities, utilities, and other needed infrastructure, facilities, and major equipment as necessary to cover the cost of services and facilities to serve planned growth while maintaining or improving levels of service.



140 GLENDORA DRIVE DESIGN REVIEW

Presented By: Brandon Northart, AICP, Associate Planner

Planning Commission | June 25, 2024




Site Description

- Project Site: 436,907 square feet (10.03-acres)
- Undeveloped
- Surrounded by open space and single-family homes

Proposed Development


- 3,779 square foot single-family home
- 1% lot coverage



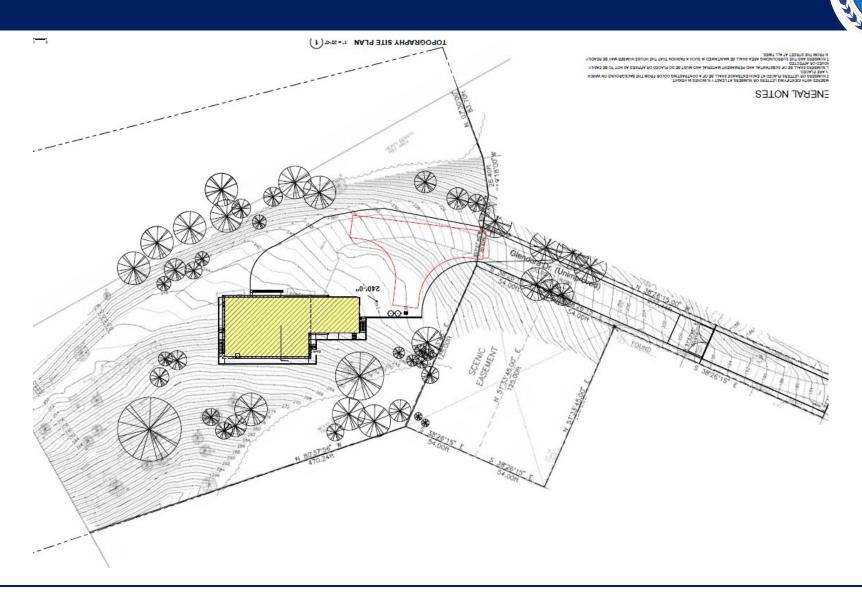



Floor Plan

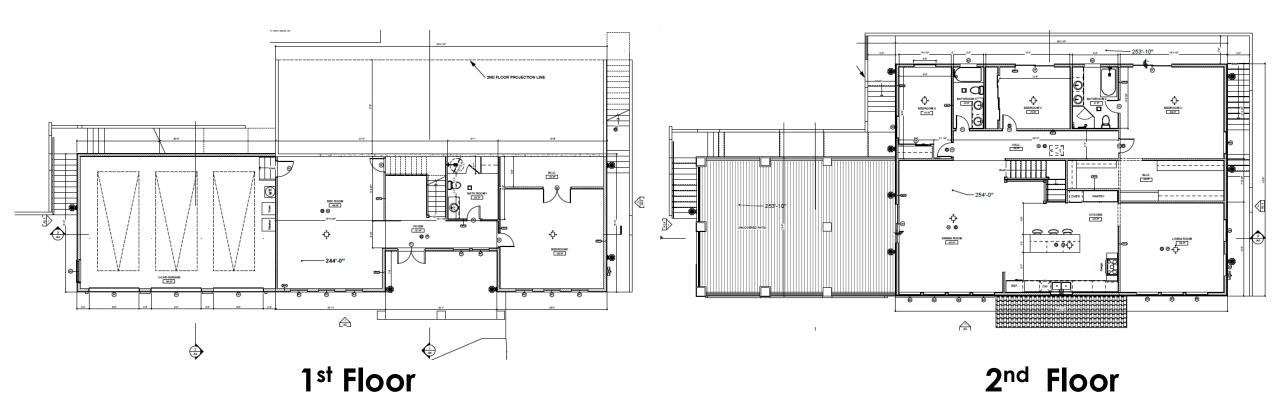





Before



After






South Elevation






West Elevation

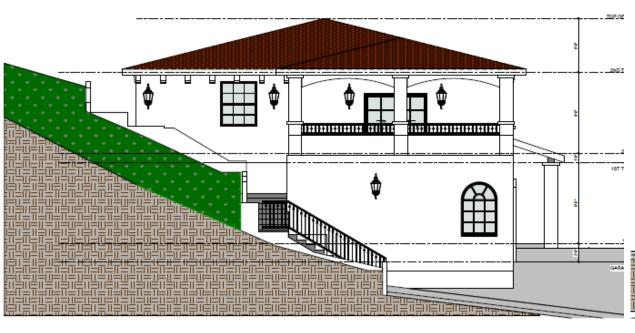

East Elevation

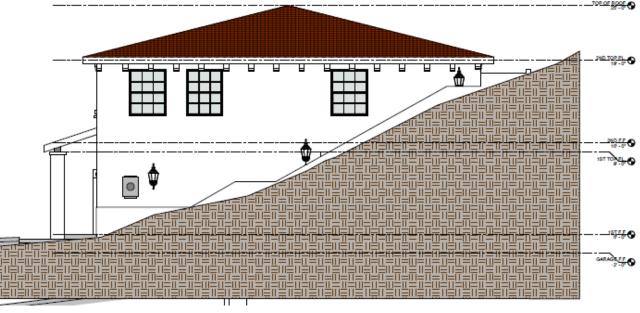

DISCUSSION



General Plan and Zoning

- General Plan: Environmentally Sensitive Land ("ESL")
- Zoning:
 - ECD-R-40
 - POPO Overlay
 - Hillside Development Regulations
 - Design Review Findings

Criteria	R-40 Requirement	ECD Requirement	Existing	Proposed	Consistent
Lot size	40,000 sq. ft.	N/A	436,907 sq. ft.	No change	Y
Density	1 dwelling per 40,000 sq. ft. of lot area	1 dwelling on sites up to 20 acres	0	1	Y
Front setback	25 ft.	N/A	N/A	134 ft. 1 in.	Y
Side setbacks	1 st Story: 15 ft. 2 nd Story: 25 ft.	N/A	N/A	East: 49 ft. 11 in. West: >100 ft.	Y
Rear setback	25 ft.	N/A	N/A	69 ft. 4 in.	Y
Lot coverage	20 percent	N/A	0 percent	1 percent	Y
Height	25 ft.	N/A	N/A	25 ft.	Y
Parking	2 covered	N/A	N/A	3 covered	Y

RECOMMENDATION



Recommendation

Conduct a public hearing and adopt Planning Commission Resolution No. 24-04, approving the Design Review application for a new 3,779 square foot single-family dwelling, located at 140 Glendora Drive, Assessor's Parcel Number 370-140-003-2, subject to conditions of approval.



Questions?



GROWTH MANAGEMENT ELEMENT UPDATE

Presented By: Michael P. Cass, Planning Manager

Planning Commission Meeting | June 25, 2024



- 1988 Pass Measure C
 - Established a countywide ½ cent sales tax for 20 years (through 2008)
 - Established a countywide Growth Management Program to plan for and accommodate increases in population, households, traffic, and jobs
- 2004 Pass Measure J
 - Extend sales tax for 25 years (through 2034)
 - Requires adoption of Urban Limit Line (completed in 2007)
 - Requires multi-modal goals, policies, and actions

DISCUSSION



- Proposed amendments to Growth Management Element based on CCTA's Model Element, include:
 - Add references to half-cent sales tax
 - Add requirement for Transportation Impact Report / Traffic Impact Study for projects estimated to generate more than 100 net new peak hour regional trips
 - Add definition of Regional Transportation Planning Committee
 - Reference Routes of Regional Significance
 - Expand definition of Action Plan
 - Modify goals, policies, and implementation measures for consistency with General Plan 2035

RECOMMENDATION



Conduct a public hearing and adopt Resolution No. 24-05, forwarding a recommendation to the City Council to approve the amendments to the Growth Management Element of the General Plan.



Questions?



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the Administrative Aide at the center console of the dais. Speakers are requested to adhere to a 3-minute limit on each item. MEETING DATE: $b - 2S - 24$ NAME: $C\lambda_{exy}(Ab_{ex})$ ORGANIZATION:	I wish to speak on an Item NOT on Agenda, during Public Comment. I wish to speak on Item # & 3, and I am (choose below): I in support of Item I in opposition of Item I neutral I do NOT wish to speak, but leave these comments for the Commission:	
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City of Martinez Planning Commission Speaker Card

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the Administrative Aide at the center console of the dais. Speakers are requested to adhere to a 3-minute limit on each item. MEETING DATE: AME	ORGANIZATION: CHANDERA CENSTALLETIEN	I wish to speak on an Item NOT on Agenda, during Public Comment. I wish to speak on Item #, and I am (choose below):	in support of Item in opposition of Item Ineutral I do NOT wish to speak, but leave these comments for the Commission:
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